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THY, INC. 1760 MORIAH WOODS BLVD., SUITE 1 MEMPHIS, TN 38117 TECK TANG, P.E. NO. 101187

THE ABOVE NAMED PROFESSIONAL ENGINEER SHALL BE RESPONSIBLE FOR THE FOLLOWING SHEETS IN ACCORDANCE OF TENN. CODE ANN. §62-2-306.

SHEET NAME	SHEET NO.
SIGNATURE SHEET	ROADWAY-SIGN2
ROADWAY INDEX AND STANDARD ROADWAY DRAWINGS	1A
ESTIMATED ROADWAY QUANTITIES	2,2-1,2-2
TYPICAL SECTIONS	2B2,2B7
TABULATED QUANTITIES	2F5
RIGHT-OF-WAY NOTES, UTILITY NOTES, UTILITY OWNERS AND	
PROPERTY MAP	3
TRAFFIC CONTROL PLANS	T2, T2B – T2G, T5I
	T5E-1, T5F, T5H,
	T5J-1, T5K, T5K-1,
	T5I

YEAR	PROJECT NO.	SHEET NO.
2025	NH-1(424)	ROADWAY-SIGN2

REV. 3-12-25: ADDED SHEET ROADWAY-SIGN2

STATE OF TENNESSEE DEPARTMENT OF TRANSPORTATION

SIGNATURE SHEET

ROADWAY INDEX

STANDARD ROADWAY DRAWINGS

DESCRIPTION

PIPE COLLAR DETAILS

TYPE "U" CROSS DRAIN ENDWALL FOR 24" PIPE (FOR 3:1, 4:1 & 6:1 SLOPES)

10-100.00 STANDARD ROADWAY TITLE SHEET,

DWG.

D-PE-24B

DESCRIPTION

OF STEEL AND PRECAST NOTES

TYPE "U" CROSS DRAIN ENDWALL FOR 24" PIPE, BILL

SHEET NAME	SHEET NO.
SIGNATURE SHEETSROADWAY-SIGN1 & F	ROADWAY-SIGN2
TITLE SHEET	1
ROADWAY INDEX AND STANDARD ROADWAY DRAWINGS	1A
STANDARD ROADWAY DRAWINGS	1A1
STANDARD STRUCTURE AND TRAFFIC OPERATIONS DRAWINGS .	1A2
PROJECT COMMITMENTS	1B
ESTIMATED ROADWAY QUANTITIES	2, 2-1, 2-2
TYPICAL SECTIONS AND PAVEMENT SCHEDULE	2B
TYPICAL SECTIONS	2B1 – 2B7
GENERAL NOTES	2C, 2C1
SPECIAL NOTES	2D
ENVIRONMENTAL NOTES	2E
TABULATED QUANTITIES	2F, 2F1 – 2F6
DETAIL SHEETS	2G
RIGHT-OF-WAY NOTES, UTILITY NOTES, UTILITY OWNERS AND	
PROPERTY MAP	3
PROPERTY MAP(S)	3A – 3E
RIGHT-OF-WAY ACQUISITION TABLE(S)	3F – 3H
PRESENT LAYOUT(S)	4 – 13, 13D
PROPOSED LAYOUT(S)	4A – 13A,13E
PROPOSED PROFILE(S)	4B – 13B
RIGHT OF WAY DETAILS	4C – 13C,13F
WOLF RIVER HAUL ROAD LAYOUTS	7D
SIDE ROADS PROFILE(S) ①	14 – 15,15A
PRIVATE DRIVE, BUSINESS, AND FIELD ENTRANCE PROFILE(S)	16 – 22,22A
DRAINAGE MAP(S)	23, 23A, 24 – 27
BARTLETT ROAD INTERSECTION LAYOUTS	28
SYCAMORE VIEW ROAD INTERSECTION LAYOUTS	29 – 30
EROSION PREVENTION & SEDIMENT CONTROL NOTES, LEGEND	
& TABULATION	31
EROSION PREVENTION & SEDIMENT CONTROL PLANS (STAGE 1) .	31A – 31L
EROSION PREVENTION & SEDIMENT CONTROL PLANS (STAGE 2).	32,32A – 32K
EROSION PREVENTION & SEDIMENT CONTROL PLANS (STAGE 3).	33,33A – 33K
EROSION PREVENTION & SEDIMENT CONTROL PLANS (STAGE 4).	34,34A – 34K
SIGNING AND PAVEMENT MARKING PLAN(S)	35 – 46
SIGN SCHEDULE SHEET(S)	47 – 50
ROADWAY CROSS SECTIONS	60 – 115
SIDE ROAD CROSS SECTIONS	116 – 126
TRAFFIC CONTROL PLANS	T1 – T19
BRIDGE PLANS	B-1
GEOTECHNICAL PLANS	G-1
LIGHTING PLANS	L-1
NATURAL STREAM DESIGN PLANS	NS-1
SIGNAL PLANS	SIG-1
STORM WATER POLLUTION PREVENTION PLAN (SWPPP) INDEX	S-1
UTILITIES INDEX	U1–1
NOTE: THE ALPHABETICAL LETTERS "I", "O" & "Q" ARE NOT USED II	N NUMBERING
OF SHEETS. SHEETS 50 - 59 ARE NOT USED.	


OF SHEETS. SHEETS 50 - 59 ARE NOT USED.	
Footnotes:	

1 Haul Road profiles follow Side Road profiles in the sheet numbering sequence.

		ND LEGENDS	D-PE-30A	06-28-19	TYPE "U" CROSS DRAIN ENDWALL FOR 30" PIPE WITH STEEL PIPE GRATE (FOR 3:1, 4:1 & 6:1 SLOPES)
RD-TP-1	10-01-24	STANDARD ADDREWATIONS A TURNING	D-PE-30B	06-28-19	TYPE "U" CROSS DRAIN ENDWALL FOR 30" PIPE, BILL OF STEEL AND PRECAST NOTES
RD-A-1	02-20-20	STANDARD ABBREVIATIONS A THROUGH L	D-PE-36A	06-28-19	TYPE "U" CROSS DRAIN ENDWALL FOR 36" PIPE WITH STEEL PIPE GRATE (FOR 3:1, 4:1 & 6:1 SLOPES)
RD-A-2 RD-L-1	02-20-20	STANDARD ABBREVIATIONS M THROUGH Z STANDARD LEGEND	D-PE-36B	06-28-19	TYPE "U" CROSS DRAIN ENDWALL FOR 36" PIPE, BILL
RD-L-1A	02 20 20	STANDARD LEGEND	D DE 00	00.04.04	OF STEEL AND PRECAST NOTES
RD-L-2	02-20-20	STANDARD LEGEND FOR UTILITY INSTALLATIONS	D-PE-99	03-04-21	TYPE "U" CROSS DRAIN ENDWALL DETAILS, PIPE GRATE & SKEWED CONNECTION
RD-L-3	03-01-23	STANDARD LEGEND FOR SIGNALIZATION AND LIGHTING	D-SEW-1A	07-07-23	TYPE "SAFETY" SIDE ENDWALL WITH STEEL PIPE GRATE, FOR 15" THRU 48" PIPES, 6:1 SLOPE
RD-L-4	10-01-24	STANDARD LEGEND FOR SIGNALIZATION AND LIGHTING	D-PE-4	06-28-19	STRAIGHT CONCRETE ENDWALLS (PIPE SIZES 18" TO 30")
RD-L-5	07-30-24	STANDARD LEGEND FOR EROSION PREVENTION AND SEDIMENT CONTROL	D-PE-5	06-28-19	STRAIGHT CONCRETE ENDWALLS FOR HORIZONTAL OVAL CONCRETE PIPES (ALL SIZES AND SKEWS)
RD-L-6	02-20-20	STANDARD LEGEND FOR EROSION PREVENTION AND SEDIMENT CONTROL	D-PEW-1		PROTECTED ENDWALLS FOR ROUND & OVAL PIPES (PIPE SIZES 18" TO 72", ALL SKEWS, 2:1 & 3:1 SLOPES)
RD-L-7	02-20-20	STANDARD LEGEND FOR EROSION PREVENTION AND SEDIMENT CONTROL	D-PEW-2		PROTECTED ENDWALLS FOR ROUND PIPES DETAILS & QUANTITIES (PIPE SIZES 18" TO 72", ALL SKEWS, 2:1 & 3:1 SLOPES)
RD-L-8	02-20-20	STANDARD LEGEND FOR NATURAL STREAM DESIGN	10-103 00	CATCHE	BASINS AND MANHOLES
10-101.00 F	ROADWAY	DESIGN STANDARDS	D-CB-DI	OATOTIL	ALTERNATE CATCH BASIN DROP INLET DETAILS
RD11-TS-6A		TYPICAL CURB & GUTTER SECTIONS WITHOUT SHOULDERS AND WITH GRASS STRIPS	D-CB-12LP	02-20-20	LOW PROFILE 32" X 32" SQUARE CONCRETE NO. 12LP CATCH BASIN FOR USE WITH 6" VERTICAL CURB
RD11-TS-6C		TYPICAL CURB AND GUTTER SECTIONS WITHOUT SHOULDERS AND WITHOUT GRASS STRIPS	D-CB-12LPA		ALTERNATE REINFORCEMENT FOR PRECAST CONCRETE 32" X 32" NO. 12LP CATCH BASIN
RD11-LR-1		MINIMUM RUNOFF LENGTHS (LR) FOR URBAN HIGHWAYS	D-CB-12P	02-20-20	STANDARD PRECAST RECTANGULAR CONCRETE NO.12 CATCH BASIN
RD11-S-11		DESIGN AND CONSTRUCTION DETAILS FOR ROADSIDE SLOPE DEVELOPMENT	D-CB-12RA	01-28-22	STANDARD PRECAST 48" CIRCULAR NO. 12 CATCH BASIN FOR USE WITH 6" VERTICAL CURB
RD11-S-11A		ROADSIDE DITCH DETAILS FOR DESIGN AND CONSTRUCTION	D-CB-12RB	02-20-20	STANDARD PRECAST 60" AND 72" CIRCULAR NO. 12 CATCH BASIN FOR USE WITH 6" VERTICAL CURB
RD11-SA-1	01-09-24	SAFETY APPROACH TO UNDERPASSES GRADING DESIGN AND SLOPE PROTECTION	D-CB-12RC	02-20-20	STANDARD PRECAST 84" THRU 120" CIRCULAR NO. 12 CATCH BASIN FOR USE WITH 6" VERTICAL CURB
RD11-SD-1		INTERSECTION SIGHT DISTANCE DESIGN AND GENERAL NOTES	D-CB-12S	02-20-20	STANDARD RECTANGULAR CONCRETE NO. 12 CATCH BASIN
RD11-SD-2		INTERSECTION SIGHT DISTANCE LANDSCAPE AND OBSTRUCTION	D-CB-12SB	02-20-20	STANDARD 4' X 4' SQUARE CONCRETE NO. 12 CATCH BASIN
RD11-SD-3		INTERSECTION SIGHT DISTANCE 2-LANE ROADWAYS	D-CB-12SC	02-20-20	STANDARD 5' 2" X 5' 2" SQUARE CONCRETE NO. 12
RD11-SD-4		INTERSECTION SIGHT DISTANCE 4-LANE AND 5-LANE UNDIVIDED ROADWAYS	D-CB-13P	02-20-20	CATCH BASIN STANDARD PRECAST RECTANGULAR CONCRETE NO.
RD-UD-3	01-09-24	UNDERDRAIN DETAILS	D 0D 101	02 20 20	13 CATCH BASIN
10-102.00	PIPE CUL	VERTS AND ENDWALLS	D-CB-13RA	01-28-22	STANDARD PRECAST 48" CIRCULAR NO. 13 CATCH BASIN FOR USE WITH 6" VERTICAL CURB
D-PB-1	03-01-23	STANDARD DETAILS FOR CONCRETE PIPE INSTALLATION	D-CB-13RB	02-20-20	STANDARD PRECAST 60" AND 72" CIRCULAR NO. 13 CATCH BASIN FOR USE WITH 6" VERTICAL CURB
D-PB-2	03-01-23	STANDARD DETAILS FOR FLEXIBLE PIPE INSTALLATION	D-CB-13RC	02-20-20	STANDARD PRECAST 84" THRU 120" CIRCULAR NO. 13 CATCH BASIN (FOR USE WITH 6" VERTICAL CURB)
D-PB-3	11-30-20	INDUCED TRENCH SOIL EMBANKMENT FOR PIPE CULVERT INSTALLATION			

TYPE	YEAR	PROJECT NO.	SHEET NO.	
PS&E	2025	NH-1(424)	1A	

REV. 3-12-25: ADDED SHEET ROADWAY-SIGN2

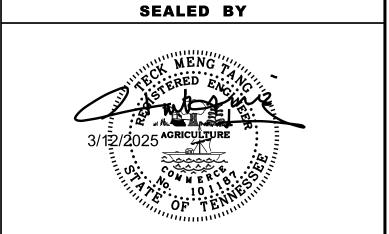

STATE OF TENNESSEE
DEPARTMENT OF TRANSPORTATION


ROADWAY INDEX AND STANDARD ROADWAY DRAWINGS

ITEM NO.	DESCRIPTION	UNIT	QUANTITY 79011-1245-04
105-01	CONSTRUCTION STAKES, LINES AND GRADES	LS	1
			<u> </u>
201-01	CLEARING AND GRUBBING	LS	1
202-01	REMOVAL OF STRUCTURES AND OBSTRUCTIONS	LS	1
202-03.02	REMOVAL OF RIGID PAVEMENT	C.Y.	7100
203-01	ROAD & DRAINAGE EXCAVATION (UNCLASSIFIED)	C.Y.	80962
203-03	BORROW EXCAVATION (UNCLASSIFIED)	C.Y.	6700
203-04	PLACING AND SPREADING TOPSOIL	C.Y.	4812
203-50	CONSTRUCTION OF HAUL ROAD	L.S.	1
209-02.05	12" TEMPORARY SLOPE DRAIN	L.F.	97
209-02.07	18" TEMPORARY SLOPE DRAIN	L.F.	24
209-02.07	FILTER SOCK (12 INCH)	L.F.	8056
209-03.23	FILTER SOCK (24 INCH)	L.F.	20604
209-05	SEDIMENT REMOVAL	C.Y.	740
209-08.02	TEMPORARY SILT FENCE (WITH BACKING)	L.F.	19601
209-08.03	TEMPORARY SILT FENCE (WITHOUT BACKING)	L.F.	25968
209-08.07	ROCK CHECK DAM PER	EACH	21
209-08.08	ENHANCED ROCK CHECK DAM	EACH	8
209-09.03	SEDIMENT FILTER BAG (15' X 15')	EACH	33
209-09.43	CURB INLET PROTECTION (TYPE 4)	EACH	112
209-13.04	TURBIDITY CURTAIN	L.F.	6390
209-40.33	CATCH BASIN PROTECTION (TYPE D)	EACH	112
209-40.34	CATCH BASIN PROTECTION (TYPE E)	EACH	10
303-10.01	MINERAL AGGREGATE (SIZE 57)	TON	2234
	ALTERNATE AA1		
203-06	WATER	M.G.	2672
303-01	MINERAL AGGREGATE, TYPE A BASE, GRADING D	TON	56555
307-01.01	ASPHALT CONCRETE MIX (PG64-22) (BPMB-HM) GRADING A	TON	415
307-01.01	ASPHALT CONCRETE MIX (PG64-22) (BPMB-HM) GRADING B-M2	TON	745
307-01.21	ASPHALT CONCRETE MIX (PG70-22) (BPMB-HM) GRADING A-S	TON	15199
307-02.01	ASPHALT CONCRETE MIX (PG70-22) (BPMB-HM) GRADING A	TON	16545
307-02.08	ASPHALT CONCRETE MIX (PG70-22) (BPMB-HM) GRADING B-M2	TON	11806
402-01	BITUMINOUS MATERIAL FOR PRIME COAT (PC)	TON	131
402-02	AGGREGATE FOR COVER MATERIAL (PC)	TON	471
403-01	BITUMINOUS MATERIAL FOR TACK COAT (TC)	TON	99
405-01.01	BITUMINOUS MATERIAL (BSC)	TON	25
405-01.02	MINERAL AGGREGATE (BSC)	TON	220
411-01.10	ACS MIX(PG64-22) GRADING D	TON	552
411-02.10	ACS MIX(PG70-22) GRADING D	TON	7656
415-01.01	COLD PLANING BITUMINOUS PAVEMENT	TON	1640

	ITEM NO.	DESCRIPTION	UNIT	QUANTITY 79011-1245-04
		ALTERNATE AA2		
	203-06	WATER	M.G.	2465
	303-01	MINERAL AGGREGATE, TYPE A BASE, GRADING D	TON	9952
_	307-01.01	ASPHALT CONCRETE MIX (PG64-22) (BPMB-HM) GRADING A	TON	415
_	307-01.08	ASPHALT CONCRETE MIX (PG64-22) (BPMB-HM) GRADING B-M2	TON	745
	307-01.21	ASPHALT CONCRETE MIX (PG70-22) (BPMB-HM) GRADING A-S	TON	15199
	307-02.01 307-02.08	ASPHALT CONCRETE MIX (PG70-22) (BPMB-HM) GRADING A ASPHALT CONCRETE MIX (PG70-22) (BPMB-HM) GRADING B-M2	TON TON	16545 11806
_	309-01.01	MINERAL AGGREGATE (A-CBC)	TON	22261
	309-01.01	PORTLAND CEMENT (A-CBC)	TON	1084
	309-01.02	BITUMINOUS MATERIAL (A-CBC)	TON	71
F	000-02	BHOWINGGO WATERIAE (A-GBO)	1014	, ,
4	102-01	BITUMINOUS MATERIAL FOR PRIME COAT (PC)	TON	19
	102-02	AGGREGATE FOR COVER MATERIAL (PC)	TON	70
F.			1011	
4	103-01	BITUMINOUS MATERIAL FOR TACK COAT (TC)	TON	99
	105.04.54	DITUMNIQUIO MATERIAL (DOC)		
_	105-01.01	BITUMINOUS MATERIAL (BSC)	TON	25
4	105-01.02	MINERAL AGGREGATE (BSC)	TON	220
4- 4	111-01.10	ACS MIX(PG64-22) GRADING D	TON	552
_	111-02.10	ACS MIX(PG70-22) GRADING D	TON	7656
4	115-01.01	COLD PLANING BITUMINOUS PAVEMENT	TON	1640
30- 6	604-07.01	RETAINING WALL NO.1 (STA. 79+33.80 TO STA. 80+01.80)	S.F.	453
12- 6	07-03.02	18" CONCRETE PIPE CULVERT (CLASS III)	L.F.	5209
37- 6	607-03.05	18" CONCRETE PIPE CULVERT (CLASS IV) JACKED-IN-PLACE	L.F.	90
12- 6	607-05.02	24" CONCRETE PIPE CULVERT (CLASS III)	L.F.	3316
12- 6	607-06.02	30" CONCRETE PIPE CULVERT (CLASS III)	L.F.	1848
	307-07.02	36" CONCRETE PIPE CULVERT (CLASS III)	L.F.	2611
_	607-08.02	42" CONCRETE PIPE CULVERT (CLASS III)	L.F.	796
	607-39.02	18" PIPE CULVERT (SIDE DRAIN)	L.F.	96
6	807-39.09	60" PIPE CULVERT (SIDE DRAIN)	L.F.	55
6	311-01.02	MANHOLES, > 4' - 8' DEPTH	EACH	9
	611-01.03	MANHOLES, > 8' - 12' DEPTH	EACH	8
6	311-01.04	MANHOLES, > 12' - 16' DEPTH	EACH	5
6	311-01.05	MANHOLES, > 16' - 20' DEPTH	EACH	1
6	311-01.20	ADJUSTMENT OF EXISTING MANHOLE	EACH	3
6	611-07.01	CLASS A CONCRETE (PIPE ENDWALLS)	C.Y.	25
6	311-07.02	STEEL BAR REINFORCEMENT (PIPE ENDWALLS)	LB.	714
6	311-07.31	18IN ENDWALL (SIDE DRAIN)	EACH	4
	611-07.60	30IN ENDWALL (CROSS DRAIN) 3:1	EACH	1
	311-09.01	ADJUSTMENT OF EXISTING CATCHBASIN	EACH	3
	311-12.01	CATCH BASINS, TYPE 12, 0' - 4' DEPTH	EACH	2
_	511-12.02	CATCH BASINS, TYPE 12, > 4' - 8' DEPTH	EACH	32
	311-12.03	CATCH BASINS, TYPE 12, > 8' - 12' DEPTH	EACH	20
	311-12.04	CATCH BASINS, TYPE 12, > 12' - 16' DEPTH	EACH	6
29- 6	311-12.05	CATCH BASINS, TYPE 12, > 16' - 20' DEPTH	EACH	2
29- 6	611-13.02	CATCH BASINS, TYPE 13, > 4' - 8' DEPTH	EACH	2
	311-14.01	CATCH BASINS, TYPE 14, 0' - 4' DEPTH	EACH	1
29- 6			1	
	311-14.02	CATCH BASINS, TYPE 14, > 4' - 8' DEPTH	EACH	27
29- 6 29- 6	611-14.02 611-14.03 611-14.04	CATCH BASINS, TYPE 14, > 4' - 8' DEPTH CATCH BASINS, TYPE 14, > 8' - 12' DEPTH CATCH BASINS, TYPE 14, > 12' - 16' DEPTH	EACH EACH EACH	27 11 3

TYPE	YEAR	PROJECT NO.	SHEET NO.
PS&E	2025	NH-1(424)	2

REV. 3-12-25: REVISED ITEM NO. 202-03.02, 203-01, 303-01, 307-01.21, 307-02.01,309-01.01, 309-01.02, 309-02, 402-01, 402-02, 403-01, 405-01.01, & 405-01.02. REMOVED ITEM NO. 204-08.01

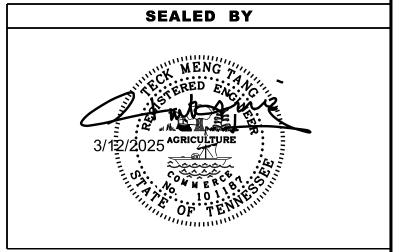

STATE OF TENNESSEE DEPARTMENT OF TRANSPORTATION

ESTIMATED ROADWAY QUANTITIES
SHEET 1 OF 3


	ESTIMATED ROADWAY QUANTITIES					
	ITEM NO.	DESCRIPTION	UNIT	QUANTITY 79011-1245-04		
29-	611-16.02	CATCH BASINS, TYPE 16, > 4' - 8' DEPTH	EACH	1		
29-	611-25.02	CATCH BASINS, TYPE 25, > 4' - 8' DEPTH	EACH	2		
29-	611-42.01	CATCH BASINS, TYPE 42, 0' - 4' DEPTH	EACH	6		
29-	611-42.02	CATCH BASINS, TYPE 42, > 4' - 8' DEPTH	EACH	2		
29-	611-42.03	CATCH BASINS, TYPE 42, > 8' - 12' DEPTH	EACH	1		
29-	611-43.02	CATCH BASINS, TYPE 43, > 4' - 8' DEPTH	EACH	1		
	611-63.01	JUNCTION STRUCTURE, 48IN ROUND, > 4FT-8FT DEPTH	EACH	6		
	611-63.51	JUNCTION STRUCTURE, 108IN ROUND, > (9FT DEPTH)	EACH	2		
7-	621-03.02	18" TEMPORARY DRAINAGE PIPE	L.F.	582		
8-	701-01.01	CONCRETE SIDEWALK (4 ")	S.F.	108731		
	701-02	CONCRETE DRIVEWAY	S.F.	4401		
33-	701-02.01	CONCRETE CURB RAMP (RETROFIT)	S.F.	208		
	701-02.02	CONCRETE DRIVEWAY (8")	S.F.	13629		
24-	701-02.03	CONCRETE CURB RAMP	S.F.	2465		
0.0	702-01	CONCRETE CURB	C.Y.	42		
28-	702-03	CONCRETE COMBINED CURB & GUTTER	C.Y.	1353		
	705-06.01	W BEAM GR (TYPE 2) MASH TL-3	L.F.	100		
	705-06.01	GR TERMINAL (ENERGY ABSORBING) MAST TL-3	EACH	8		
	705-06.25	THRIE BEAM BRIDGE TRANSITION MASH TL-3	EACH	8		
	700-00.20	THRE BEAMBRIDGE TRANSPORT WASTITE-3	LAOIT	0		
	706-01	GUARDRAIL REMOVED	L.F.	756		
	707-08.11	HIGH VISIBILITY CONSTRUCTION FENCE	LF	1065		
	709-05.05	MACHINED RIP-RAP (CLASS A-3)	TON	1050		
27-	709-05.06	MACHINED RIP-RAP (CLASS A-1)	TON	3212		
23-	709-05.08	MACHINED RIP-RAP (CLASS B)	TON	3981		
34-	710-02	AGGREGATE UNDERDRAINS (WITH PIPE)	L.F.	16156		
	712-01	TRAFFIC CONTROL	LS · =	1		
9-	712-02.02	INTERCONNECTED PORTABLE BARRIER RAIL	L.F.	19565		
9-	712-02.60 712-04.50	TEMPORARY WORK ZONE CRASH CUSHION (MASH TL-3) BARRIER RAIL DELINEATOR	EACH EACH	54 200		
	7 12-04.50	DAINILITYAL DELINEATOR	LACIT	200		
	712-04.01	FLEXIBLE DRUMS (CHANNELIZING)	EACH	721		
	712-05.01	WARNING LIGHTS (TYPE A)	EACH	28		
	712-05.03	WARNING LIGHTS (TYPE C)	EACH	47		
	712-06	SIGNS (CONSTRUCTION)	S.F.	1048		
	712-07.02	TEMPORARY BARRICADES (TYPE II)	L.F.	65		
	712-07.03	TEMPORARY BARRICADES (TYPE III)	L.F.	4249		
0.5	712-08.03	ARROW BOARD (TYPE C)	EACH	3		
35- 40	712-08.08	SPEED FEEDBACK SIGN ASSEMBLY	EACH	6		
10- 10-	712-09.02 712-09.03	REMOVABLE PAVEMENT MARKING (8" BARRIER LINE) REMOVABLE PAVEMENT MARKING (CHANNELIZATION STRIPING)	L.F. S.Y.	14664 31		
10-	712-09.03	REMOVABLE PAVEMENT MARKING (CHANNELIZATION STRIPING) REMOVABLE PAVEMENT MARKING (STOP LINE)	L.F.	314		
10-	712-09.05	REMOVABLE PAVEMENT MARKING (ARROW)	EACH	26		
10-	712-09.08	REMOVABLE PAVEMENT MARKING (6" LINE)	L.F.	26467		
	713-02.14	FLEXIBLE DELINEATORS (WHITE)	EACH	13		
	713-11.01	"U" SECTION STEEL POSTS	LB.	1469		
	713-11.02	PERFORATED/KNOCKOUT SQUARE TUBE POST	LB.	300		
	713-11.21	P POST SLIP BASE	EACH	3		
	713-13.02	FLAT SHEET ALUMINUM SIGNS (0.080" THICK)	S.F.	231		
47	713-13.03	FLAT SHEET ALUMINUM SIGNS (0.100" THICK)	S.F.	278		
17-	713-15 713-15.02	REMOVAL OF SIGNS, POSTS AND FOOTINGS REMOVAL & RELOCATION OF SIGN & SUPPORT	LS EACH	<u>1</u> 5		
	713-15.02	METAL BARRICADE (TYPE III)	EACH	3		
	, 10 10.00			<u> </u>		

	DESCRIPTION	UNIT	QUANTITY 79011-1245-
			73011-12-0-
713-16.01	CHANGEABLE MESSAGE SIGN UNIT	EACH	19
713-16.07	END OF ROADWAY SIGN AND SUPPORT	EACH	2
716-01.07	TEMPORARY RAISED PAVEMENT MARKER, YELLOW	EACH	99
716-01.21	SNOWPLOWABLE RAISED PAVEMENT MARKERS (BI-DIR) (1 COLOR)	EACH	325
716-01.22	SNOWPLOWABLE RAISED PAVMENT MARKERS (MONO-DIR)(1 COLOR)	EACH	504
716-01.30	REMOVAL OF SNOWPLOWABLE REFLECTIVE MARKER	EACH	550
716-02.04	PLASTIC PAVEMENT MARKING (CHANNELIZATION STRIPING)	S.Y.	220
716-02.05	PLASTIC PAVEMENT MARKING (STOP LINE)	L.F.	1192
716-02.06	PLASTIC PAVEMENT MARKING (TURN LANE ARROW)	EACH	44
716-02.08	PLASTIC PAVEMENT MARKING (8" DOTTED LINE)	L.F.	2736
716-02.09	PLASTIC PAVEMENT MARKING (LONGITUDINALCROSS-WALK)	L.F.	1692
716-02.12	PLASTIC PAVEMENT MARKING (8IN LINE)	L.M.	0.86
716-03.01	PLASTIC WORD PAVEMENT MARKING (ONLY)	EACH	25
716-04.02	PLASTIC PAVEMENT MARKING (DOUBLE TURNING ARROW)	EACH	5
716-04.04	PLASTIC PAVEMENT MARKING (TRANSVERSE SHOULDER)	L.F.	44
716-04.12	PLASTIC PAVEMENT MARKING (YIELD LINE)	S.F.	12
716-04.13	PLASTIC PAVEMENT MARKING (BIKELANE SYMBOL & ARROW)	EACH	15
716-04.15	PLASTIC PAVEMENT MARKING-BIKE SYMBOL/ARROW SHARED	EACH	3
716-05.02	PAINTED PAVEMENT MARKING (8" LINE)	L.F.	21983
716-05.04	PAINTED PAVEMENT MARKING (CHANNELIZATION STRIPING)	S.Y.	50
716-05.05	PAINTED PAVEMENT MARKING (STOP LINE)	L.F.	386
716-05.06	PAINTED PAVEMENT MARKING (TURN LANE ARROW)	E.A.	29
716-05.20	PAINTED PAVEMENT MARKING (6" LINE)	LF	37185
716-08.05	REMOVAL OF PAVEMENT MARKING (STOP LINE)	L.F.	348
716-08.06 716-08.08	REMOVAL OF PAVEMENT MARKING (TURN LANE ARROW)	EACH EACH	33
716-08.08	REMOVAL OF PAVEMENT MARKING (DOUBLE TURNING ARROW) REMOVAL OF PAVEMENT MARKING (DOTTED LINE)	L.F.	2 548
716-08.09	REMOVAL OF PAVEMENT MARKING (ONLY)	EACH	11
716-08.11	REMOVAL OF PAVEMENT MARKING (LINE)	L.M.	10.872
716-00.20	ENHANCED FLATLINE THERMO PVMT MRKNG (6IN LINE)	L.M.	14.565
716-12.02	ENHANCED FLATLINE THERMO PVMT MRKNG (6IN DOTTED LINE)	L.F.	1832
717-01	MOBILIZATION	LS	1
			1
740-07.04	GEOGRID REINFORCEMENT TYPE 2	S.Y.	6540
740-10.03	GEOTEXTILE (TYPE III)(EROSION CONTROL)	S.Y.	2817
740-10.04	GEOTEXTILE (TYPE IV)(STABILIZATION)	S.Y.	38293
801-01	SEEDING (WITH MULCH)	UNIT	100
801-01.07	TEMPORARY SEEDING (WITH MULCH)	UNIT	94
801-02.15	FERTILIZER	TON	1
801-03	WATER (SEEDING & SODDING)	M.G.	273
801-07	SEED (SUPPLEMENTAL APPLICATION)	LB.	22
801-08	FERTILIZER (SUPPLEMENTAL APPLICATION)	TON	1
803-01	SODDING (NEW SOD)	S.Y.	26940
806-02.12	MOWING, WEEDEATING & LITTER PICKUP (URBAN AREA)	CYCL	12

TYPE	YEAR	PROJECT NO.	SHEET NO.
PS&E	2025	NH-1(424)	2-1

712-09.03,712-09.04, 712-09.05, 712-09.08, & 713-16.01 716-02.08 ADDED ITEM NO.716-05.02, 716-05.04, 716-05.05, 716-05.06 &716-05.20.

REV. 3-12-25: REVISED ITEM NO. 712-06, 712-09.02,

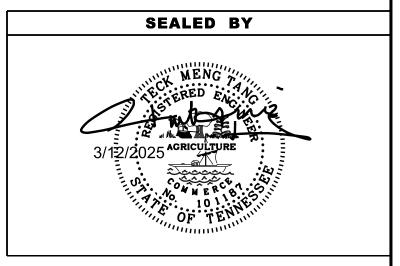

STATE OF TENNESSEE DEPARTMENT OF TRANSPORTATION

ESTIMATED ROADWAY QUANTITIES SHEET 2 OF 3

	Tab	I
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	OJECTS/9700	
1	1990s PR	I
	ALL	

		FOOTNOTES
	(1)	INCLUDES THE REMOVAL AND DISPOSAL OF CURBS, PAVEMENT, PIPES, MANHOLES, CONDUITS, CATCH BASINS AND ANY OTHER ITEMS WITHIN THE CONSTRUCTION LIMITS NOT DESIGNATED TO REMAIN INCLUDING ENCROACHMENT ITEMS. ALSO INCLUDES CAPPING EX BOX CULVERTS AT STA. 105+80 AND STA. 113+153. SEE SHEET 2F6 FOR LIST ESTIMATED QUANTITIES AND ENCROACHMENT ITEMS.
	(2)	FOR THE REMOVAL AND DISPOSAL OF A CONCRETE SLAB UNDERNEATH THE SR-1 PAVEMENT APPROXIMATELY FROM STA. 38+75 TO STA. 53+51, 92+50 TO STA. 118+50 AND STA, 121+40 TO STA. 125+60. AN ADDITIONAL 1605 C.Y. ARE FOR THE INSTALLATION OF THE WATER LINE
•	(3)	SEE SUB-SECTION 209.07 OF THE STANDARD SPECIFICATIONS FOR MAINTENANCE REPLACEMENT. ALL QUANTITIES ARE TO BE USED AS DIRECTED BY THE ENGINEER.
•	(4)	THE CONTRACTOR HAS THE OPTION OF USING THE PERFORMANCE GRADE MIX OR REGULAR ASPHALT ON THE PAVING OF DRIVEWAYS AND BUSINESS ENTRANCES.
•	(5)	INCLUDES 14 L.F. ON PHASE 1 CONSTRUCTION.
	(6)	EXISTING GRATE, AND FRAME TO BE SALVAGED AND REUSED.
	(7)	FOR USE IN THE PHASE 1 CONSTRUCTION.
•	(8)	INCLUDES 814 S.F. FOR ISLAND AT BARTLETT ROAD AND 4360 S.F. FOR ISLANDS AT SYCAMORE VIEW ROAD.
,	(9)	THIS ITEM SHALL BE A PORTABLE ENERGY ABSORBING TERMINAL MEETING THE REQUIREMENTS OF AASHTO MASH FOR TEST LEVEL 3. THE PAY ITEM WILL INCLUDE FURNISHING AND INSTALLING ALL COMPONENTS AS SHOWN ON THE MANUFACTURER'S DRAWING.
((10)	TRAFFIC CONTROL ITEMS DURING CONSTRUCTION.
((11)	ITEM NO. 203-50 SHALL INCLUDE GEOTEXTILE (TYPE IV), BORROW EXCAVATION (GRADED SOLID ROCK) OR MACHINED RIP-RAP (CLASS A-1, CLASS B, OR CLASS C), MINERAL AGGREGATE (SIZE 57) AND TEMPORARY DRAINAGE PIPE (IF APPLICABLE). THE MINERAL AGGREGATE INCLUDES AN ADDITIONAL TEN (10) PERCENT FOR MAINTENANCE.
((12)	BEDDING MATERIAL SHALL BE INCLUDED IN THE COST OF THE PROPOSED PIPE CULVERT.
((13)	ITEM TO BE USED AS DIRECTED BY THE ENGINEER.
((14)	THE COST OF REMOVAL SHALL BE INCLUDED IN THE PRICE BID FOR RAISED PAVEMENT MARKERS.
((15)	CONTRACTOR MAY ELECT TO SUBSTITUTE PREFORMED PLASTIC FOR THE THERMOPLASTIC. PREFORMED PLASTIC SHALL BE PAID FOR AT THE SAME UNIT PRICE AS BID FOR THERMOPLASTIC.
((16)	ITEM INCLUDES LITTER AND TRASH REMOVAL. THIS WORK WILL NOT BE MEASURED AND PAID FOR DIRECTLY BUT WILL BE INCLUDED IN THE COST OF ITEM NO. 806-02.12, MOWING, WEDEATING & LITTER PICKUP (URBAN AREA), PER CYCL.
((17)	INCLUDES A MINIMUM OF 61 SIGNS AND ANY ADDITIONAL SIGNS ENCOUNTERED WITHIN PROJECT LIMIT. REFER TO SHEET 49 FOR OTHER SIGNS.
((18)	REFER TO GRADING NOTES ON SHEET 2D.
((19)	INCLUDES 2526 L.F. USED IN NSD. REFER TO NSD PLANS FOR FURTHER DETAILS.
((20)	INCLUDES 525 S.Y. USED IN NSD. REFER TO NSD PLANS FOR FURTHER DETAILS.
,	(24)	INCLUDES A FACILITIES IN NED DEFED TO NED DI ANS FOD FURTUED DETAILS

INCLUDES 1 EACH USED IN NSD. REFER TO NSD PLANS FOR FURTHER DETAILS.


FOOTNOTES

(22)	INCLUDES 13 TONS USED IN NSD. REFER TO NSD PLANS FOR FURTHER DETAILS.
	INCLUDES 322 TONS USED IN TRAFFIC CONTROL & 59 TONS USED IN EPSC.
	INCLUDES 1840 TONS AT BRIDGE ENDS.

- INCLUDES 374 TONS USED IN NSD. REFER TO NSD PLANS FOR FURTHER DETAILS.
 INCLUDES 3145 TONS USED IN TWO BRIDGES.
- (24) INCLUDES 96 S.F. FOR CURB RAMPS AT ACCESS RAMPS STA. 52+50 & STA. 61+63
- (25) INCLUDES 11 FOR INTERSECTION DETOURS
- (26) INCLUDES 4 M.G. FOR TRAFFIC CONTROL.
- (27) INCLUDES 256 TONS FOR EPSC AND 665 TON FOR GEOTECHNICAL
- (28) INCLUDES 11 C.Y. FOR SUMMER TREES DR.
- (29) INCLUDES COST OF TYING IN UNDERDRAINS.
- (30) REFER TO DRAWING W-SG-1 FOR GRAVITY WALL TYPE RETAINING WALLS
- (31) INCLUDES 1635 S.Y. FOR BRIDGE ENDS AND 36658 S.Y. FOR GEOTECHNICAL
- (32) FOR BRIDGE ENDS
- (33) FOR THE COST OF REPLACING CURB RAMPS AT THE LIMIT OF CONSTRUCTION.
- (34) INCLUDES 1288 L.F. FOR SYCAMORE VIEW RD.
- (35) TO BE PLACED WHEN ENTERING TO 35 MPH WORK ZONE AND APPROACHING BRIDGES.
- (36) ADDITIONAL BORROW IS REQUIRED DUE TO EXISTING PAVEMENT REMOVAL THAT IS NOT SUITABLE FOR EMBANKMENT
- (37) REFER TO SHEET 2F3 FOR DETAILS


TYPE	YEAR	PROJECT NO.	NO.
PS&E	2025	NH-1(424)	2-2


REV. 3-12-25: REVISED FOOTNOTES (2) & (25)

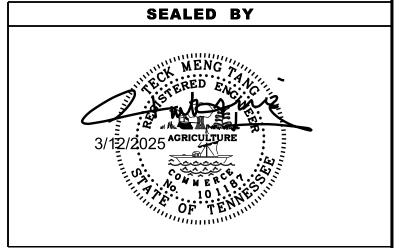

STATE OF TENNESSEE DEPARTMENT OF TRANSPORTATION

ESTIMATED ROADWAY QUANTITIES
SHEET 3 OF 3

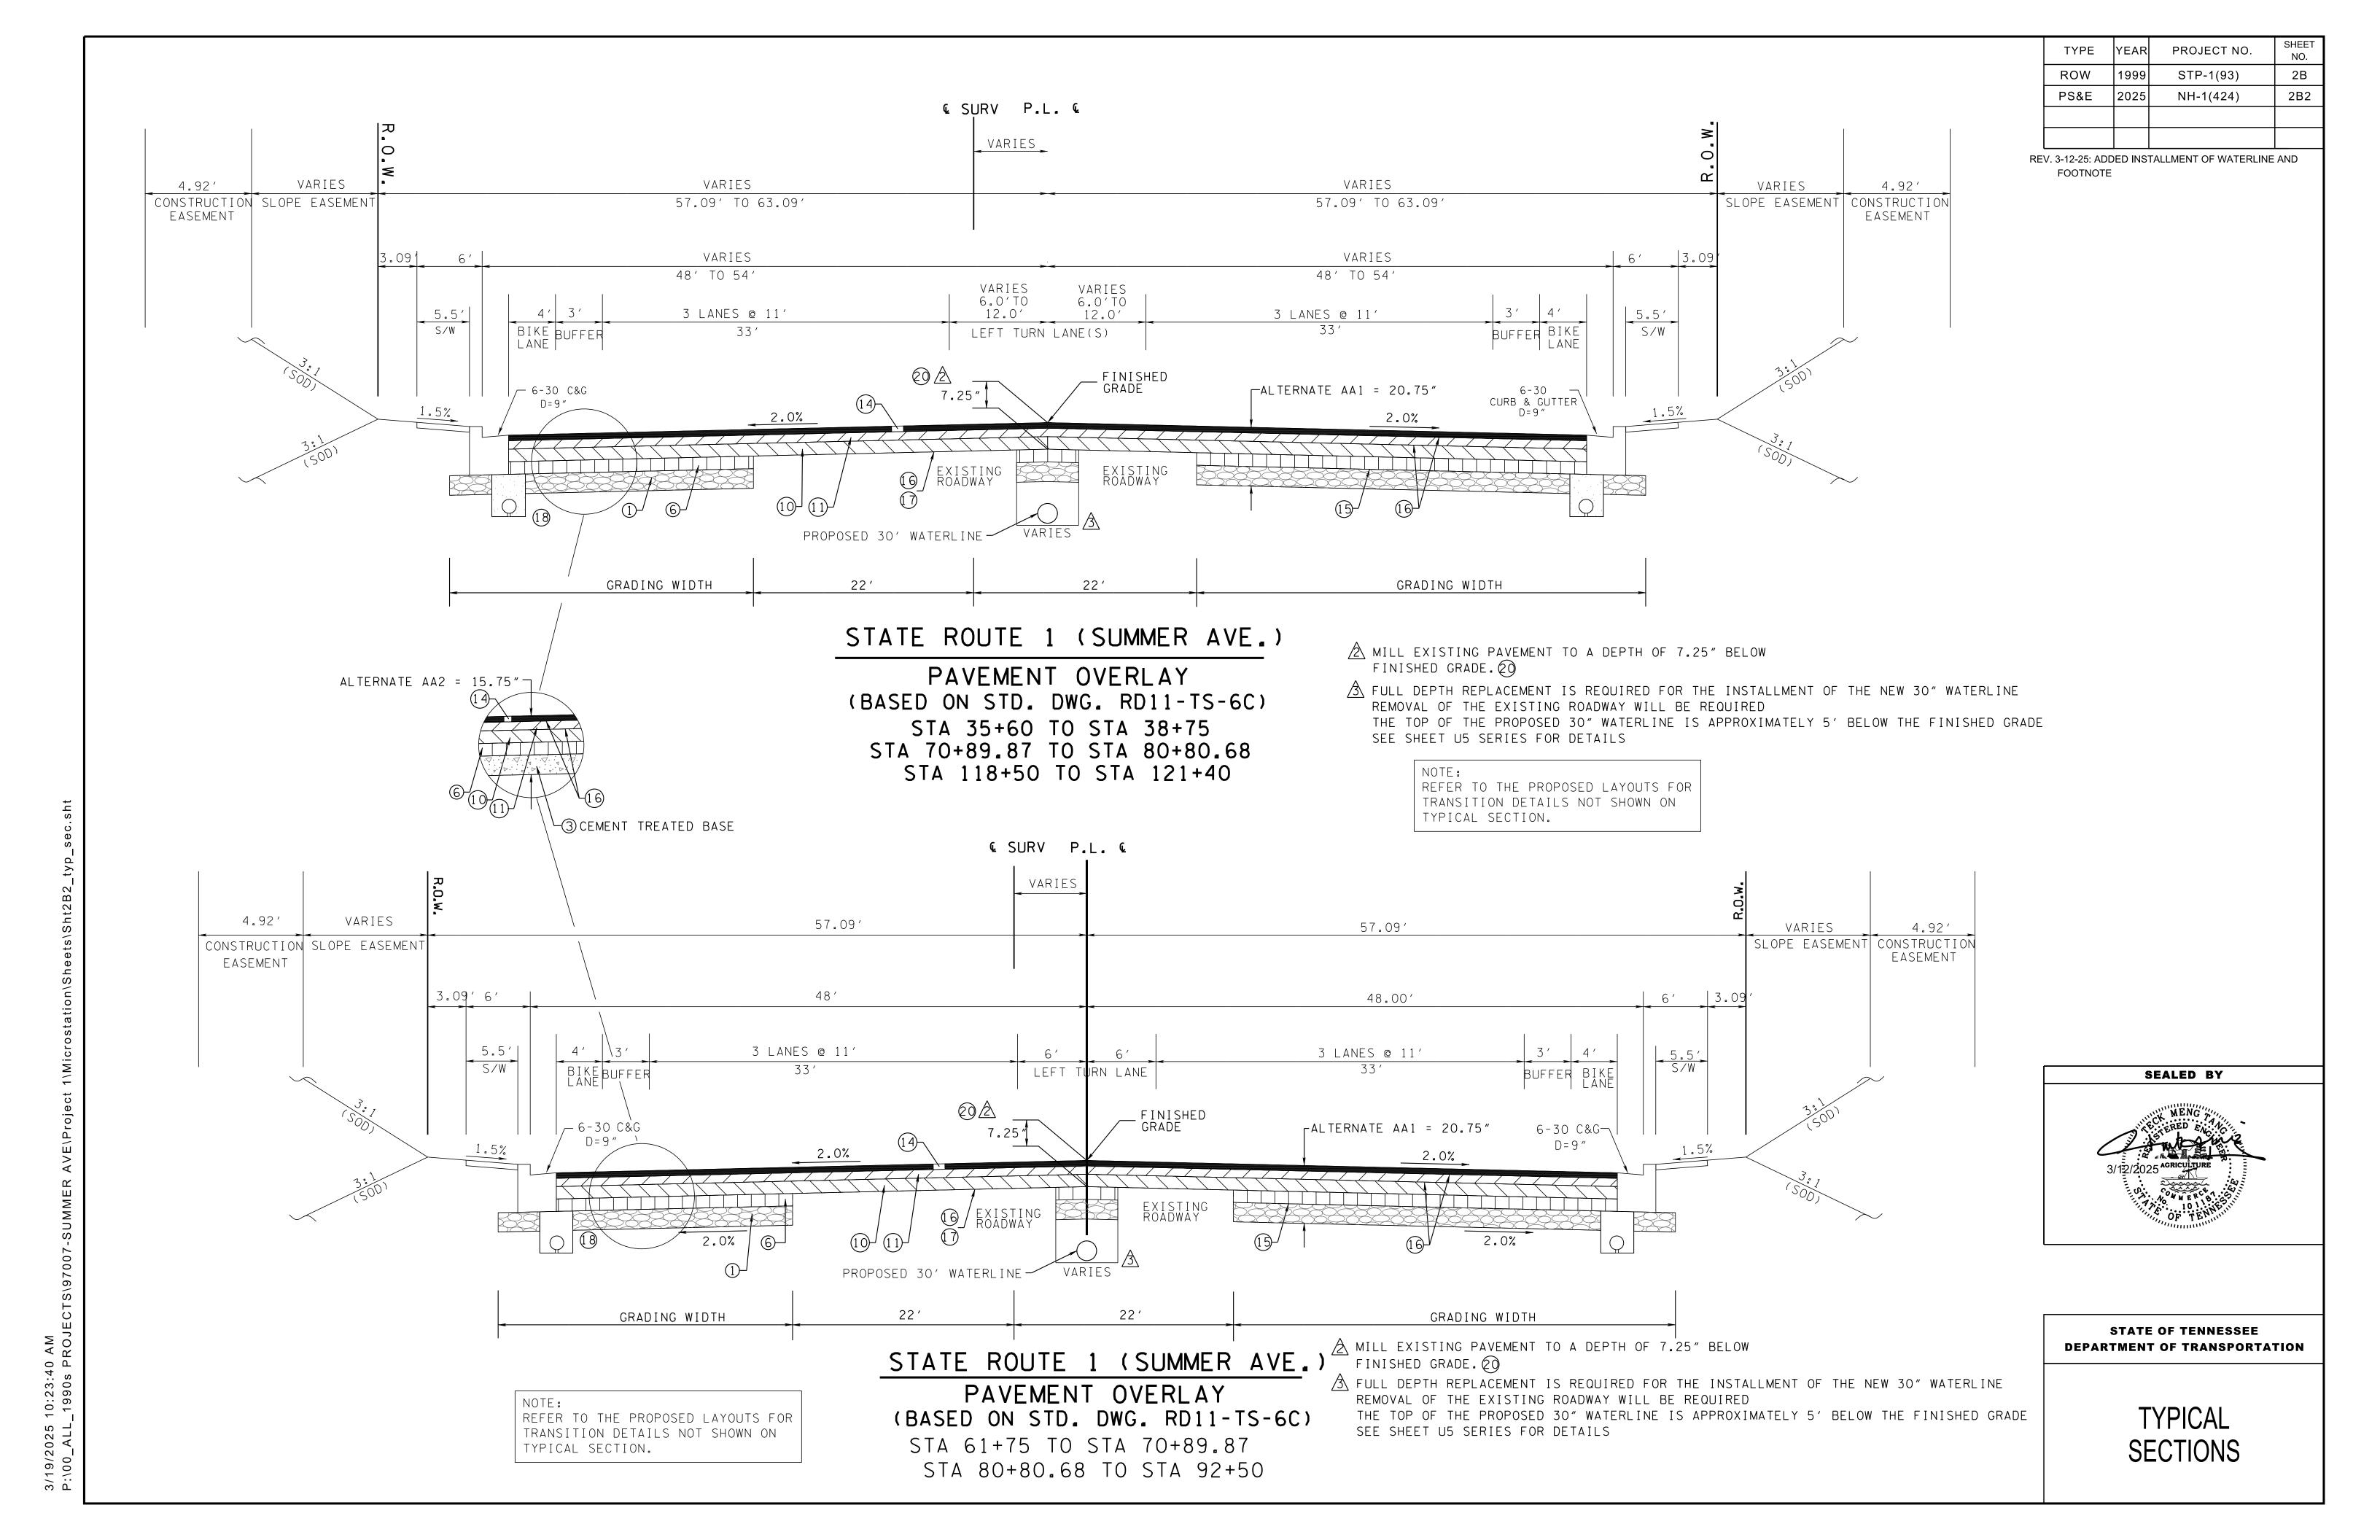

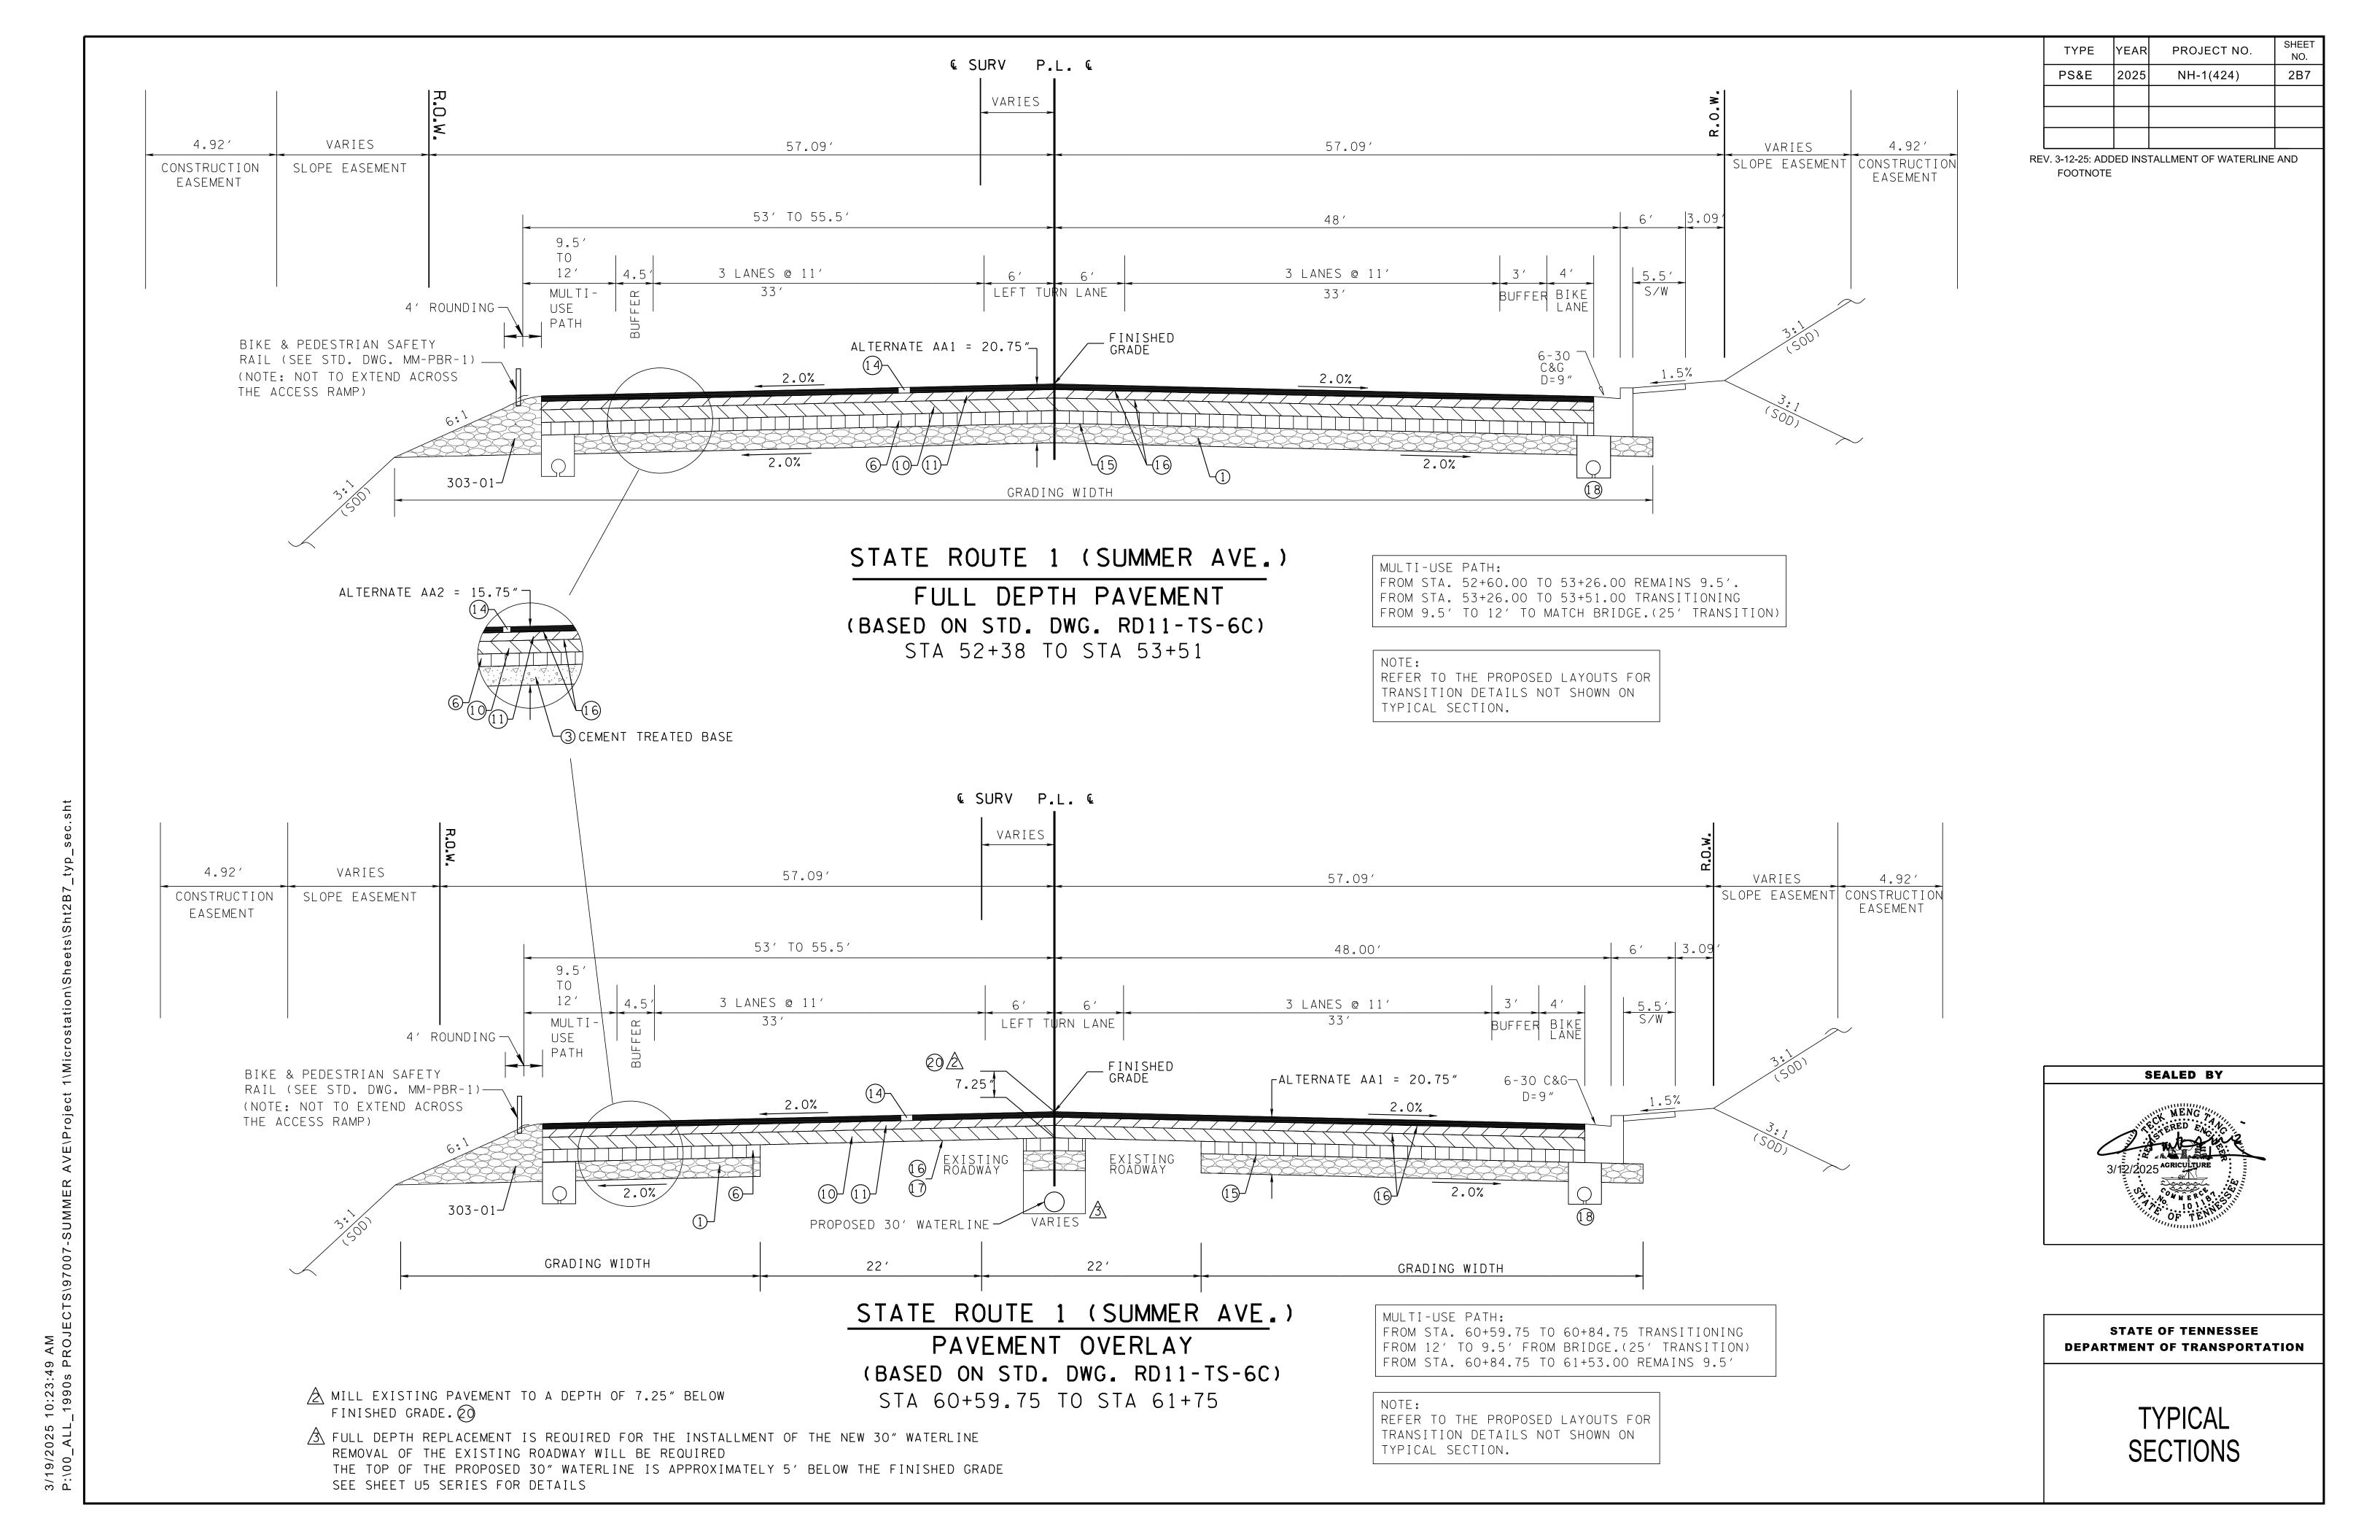

					ENDV	VALLS								
SHEET NO.	LOCATION	STATION	OFFSET (FT.)	DRAINAGE CODE	STRUCTURE TYPE	PIPE SIZE (IN.)	STANDARD DRAWING	CLASS"A" CONC. 611-07.01 (C.Y.)	REINF. STEEL 611-07.02 (LB.)	STRUC. STEEL 611-07.03 (LB.)	MACHINED RIP-RAP 709-05.06 CL"A-1" (TONS)	MACHINED RIP-RAP 709-05.08 CL"B" (TONS)	18IN ENDWALL (S.D.) 611-07.31 (EACH)	30 END\ (C.D 611- (EA
	SR1	54+46.20	91.9 LT	40	A	36	D-PEW-1	3.89	73.0	(LD.) -	8	77	(EACH)	(=
	SR1	54+46.20	85.3 RT	25	A	36	D-PEW-1	3.89	73.0	_	13	55		\vdash
7A —	SR1	59+05.50	95.0 LT	41	ST	24	D-PE-4	1.5	70.0		352	74		
										-	-			
8A	SR1	62+54.93	126.07 RT	58	ST	18	D-PE-4	1	45.0	-	37			
	SR1	66+60.34	125.34 RT	62	ST	18	D-PE-4	1	45.0	-	57			
10A —	SR1	87+34.82	66.34 RT	79	ST	30	D-PE-4	2	93.0	-	-	-		
	SR1	99+35.40	67.5 RT	91	A	42	D-PEW-1	4.72	79.0	-	-	60		
	SR1	99+32.40	67.5 LT	106	ST	30	D-PE-4	2	93.0		-	60		
11A	SR1	103+51.20	92.0 LT	108A	U	30	D-PE-30A				710	43		
	SR1	103+51.20	92.0 RT	118	Α	36	D-PEW-1	3.89	73.0	-	1114	93		
	SR1	113+90.80	74.0 RT	126	ST	24	D-PE-4	1.5	70.0	-	-	-		
12A	SR1	113+95.42	68.93 LT	114A	SEW	18	D-SEW-1A						1	
	SR1	114+45.42	68.39 LT	114B	SEW	18	D-SEW-1A						1	
	SR1	115+87.08	69.07 LT	116A	SEW	18	D-SEW-1A						1	
13A	SR1	116+32.99	68.74 LT	117A	SEW	18	D-SEW-1A						1	
OTALS								25	714.0	0	2291	462	4	

						PR	OPOSE) GUARDI	RAIL									
T							GUARDRAIL			TERMINAL								
SHEET						THRIE BEAM BRIDGE TRAN.	W BEAM GR (TYPE 2)	THRIE BEAM BRIDGE TRAN.	TYPE 12	TYPE 13	TYPE 38	TYPE 21						
	LOCATION	SI	DE	STAT	TONS	MASH TL-3	MASH	MASH TL-3		MASH TL3	MASH TL3	MASH TL2	REMARKS					
NO.						(20.645')	TL-3	(11.365')	VARIES	(9.375')	(46.875')	(21.875')						
		Īπ	RT	FROM	то	705-06.25	705-06.01	705-06.25	705-04.02	705-06.10	705-06.20	705-06.30						
		<u> </u>		FROW	10	EACH	(L.F.)	EACH	(EACH)	(EACH)	(EACH)	(EACH)						
		Х		52+73 +/-	53+50 +/-	1	12.50				1		·					
			Х		53+50 +/-	1	12.50				1							
7A						X	X	Х		60+60 +/-		1	12.50				1	
			Х	60+60 +/-	61+38 +/-	1	12.50				1							
	SR1	X	Н	98+20 +/-	98+97 +/-	1	12.50				1							
			Х	98+20 +/-		1	12.50				1							
11A		Х		101+01 +/-	101+78 +/-	1	12.50				1							
			Х	101+01 +/-	101+78 +/-	1	12.50				1							
	Т	OTA	LS LS			8	100.00	0	0	0	8	0						

TYPE	YEAR	PROJECT NO.	SHEET NO.
PS&E	2025	NH-1(424)	2F5

REV. 3-12-25: REVISED ITEM NO. 203-01, 303-01, 307-01.21, 307-02.01, 309-01.01, 309-01.02, 309-02, 402-01, 402-02, 403-01, 405-01.01, & 405-01.02. REVISED ESTIMATED GRADING QUANTITIES TABLE

	ESTIM <i>A</i>	ATED GRADII	NG QUAN	TITIES				
DES	CRIPTION	UNADJUSTED \	OLUMES (CY)	ADJUSTED VOLUMES (CY)	BALANCI	E SU	JMMARY	
		EXC.	EMB.	EXC.	SHRINK = 30	%	SWELL =	%
*** MAINLINE PHASE 3		40752	14995	28527				
MAINLINE PHASE 2		20046	16552	14033				
MAINLINE PHASE 1		3279	120	2296	EXC.		EMB.	
* UNDERCUTTING		6500	0	4550				
SIDE ROADS		3854	832	2698				
PVT. DRIVES, BUSINESS	AND FIELD ENTRANCES	1501	1937	1051	53254	VS.	-34436	
TEMPORARY CONSTRUCT	TION EXITS	144	0	101				
TOPSOIL (EMB.)		2179			AVAILABLE	=	18818	
TOPSOIL (EXC.)		2707						
	TOPSOIL TOTALS (SEE	TOPSOIL TABLE)			WASTE MATERIAL	=	24464	
ROCK (C.Y.)		TOTALS (C.Y.)						
EXC. EMB.	**EXC. (UNCL.) EMB. (UNC	L.) EXC (COMMON)	EXC. (AVAIL.)	EXC. (ADJ.)				
	80962 34436	80962	76076	53254				

			ТОГ	PSOIL			
		F EXISTING	3 TOPSOIL I	S SUITABLE	FOR REUSE		
PROPOSED SLOPE AREA S.F.	EXISTING TOPSOIL (EXC.)	EXISTING TOPSOIL (EMB.)	EXISTING TOPSOIL (TOTAL) C.Y.	REQUIRED TOPSOIL C.Y.	PLACING TOPSOIL 203-04 C.Y.	FURNISHED TOPSOIL 203-07 C.Y.	EXCESS TOPSOIL C.Y.
259830	2707	2179	4886	4812	4812	0	74
	IF E	EXISTING T	OPSOIL IS I	NOT SUITABL	E FOR REU	SE	
PROPOSED SLOPE AREA S.F.	EXISTING TOPSOIL (EXC.)	EXISTING TOPSOIL (EMB.)	EXISTING TOPSOIL (TOTAL) C.Y.	REQUIRED TOPSOIL C.Y.	PLACING TOPSOIL 203-04 C.Y.	FURNISHED TOPSOIL 203-07 C.Y.	EXCESS TOPSOIL C.Y.
0	N/A	N/A	N/A	0	N/A	0	N/A


*NOTE:- UNDERCUTTING TO BE USED AS DIRECTED BY THE ENGINEER

**NOTE:- EXCAVATION INCLUDES 22,178 CY OF PAVEMENT REMOVAL.

***NOTE:- EXCAVATION INCLUDES 17,891 CY FOR WATERLINE INSTALLATION

			PAVEME	ENT QUA	NTITIES	"ALTER	RNATE	AA1"						
		PAY ITEMS												
LOCATION	303-01 (TON)	307-01.01 (TON)	307-01.08 (TON)	307-01.21 (TON)	307-02.01 (TON)	307-02.08 (TON)	402-01 (TON)	402-02 (TON)	403-01 (TON)	405-01.01 (TON)	405-01.02 (TON)	411-01.10 (TON)	411-02.10 (TON)	415-01.01 (TON)
SR 1 (Phase 1)	3289.0	Х	х	573.0	Х	460.0	7.0	28.0	4.0	Х	х	х	253.0	Х
SR 1 (Phase 2&3)	43661.0	Х	Х	12980.0	15604.0	10412.0	104.0	372.0	87.0	19.0	169.0	Х	6863.0	1625.0
BARTLETT	1351.0	415.0	251.0	х	Х	Х	3.0	9.0	1.0	Х	Х	147.0	Х	Х
SHELBY OAKS	683.0	х	Х	х	236.0	131.0	2.0	6.0	1.0	Х	Х	Х	69.0	Х
SUMMER TREES	322.0	х	68.0	х	Х	Х	1.0	3.0	1.0	Х	Х	30.0	Х	Х
SYCAMORE VIEW	1645.0	х	Х	352.0	447.0	803.0	3.0	14.0	4.0	6.0	51.0	х	471.0	15.0
FRONTAGE RD	350.0	Х	71.0	Х	Х	Х	1.0	3.0	1.0	Х	Х	38.0	Х	Х
PRIVATE DRIVES	1218.0	Х	355.0	Х	Х	Х	Х	Х	Х	Х	Х	337.0	Х	Х
WATERLINE INSTALLATION/REMOVAL	4036.0	Х	Х	1294.0	258.0	Х	10.0	36.0	Х	Х	Х	Х	Х	Х
TOTALS	56555.0	415.0	745.0	15199.0	16545.0	11806.0	131.0	471.0	99.0	25.0	220.0	552.0	7656.0	1640.0

				PAVE	EMENT (QUANTII	IES "AL	TERNAT	E AA2"								
	PAY ITEMS																
LOCATION	303-01 (TON)	307-01.01 (TON)	307-01.08 (TON)	307-01.21 (TON)	307-02.01 (TON)	307-02.08 (TON)	309-01.01 (TON)	309-01.02 (TON)	309-02 (TON)	402-01 (TON)	402-02 (TON)	403-01 (TON)	405-01.01 (TON)	405-01.02 (TON)	411-01.10 (TON)	411-02.10 (TON)	415-01.01 (TON)
SR 1 (Phase 1)	3289.0	х	Х	573.0	х	460.0	Х	х	х	7.0	28.0	4.0	х	х	Х	253.0	Х
SR 1 (Phase 2&3)	316.0	х	Х	12980.0	15604.0	10412.0	20805.0	1013.0	66.0	Х	Х	87.0	19.0	169.0	Х	6863.0	1625.0
BARTLETT	1351.0	415.0	251.0	Х	Х	Х	Х	х	х	3.0	9.0	1.0	х	Х	147.0	Х	Х
SHELBY OAKS	683.0	х	Х	Х	236.0	131.0	Х	х	Х	2.0	6.0	1.0	х	Х	Х	69.0	Х
SUMMER TREES	322.0	х	68.0	Х	Х	Х	Х	х	Х	1.0	3.0	1.0	х	Х	30.0	Х	Х
SYCAMORE VIEW	1645.0	х	Х	352.0	447.0	803.0	Х	х	Х	3.0	14.0	4.0	6.0	51.0	Х	471.0	15.0
FRONTAGE RD	350.0	х	71.0	Х	Х	Х	Х	х	Х	1.0	3.0	1.0	х	Х	38.0	Х	Х
PRIVATE DRIVES	1218.0	х	355.0	Х	Х	Х	Х	Х	Х	х	Х	Х	Х	Х	337.0	Х	Х
WATERLINE INSTALLATION/REMOVAL	778.0	х	Х	1294.0	258.0	Х	1456.0	71.0	5.0	2.0	7.0	Х	Х	Х	х	Х	Х
TOTALS	9952.0	415.0	745.0	15199.0	16545.0	11806.0	22261.0	1084.0	71.0	19.0	70.0	99.0	25.0	220.0	552.0	7656.0	1640.0

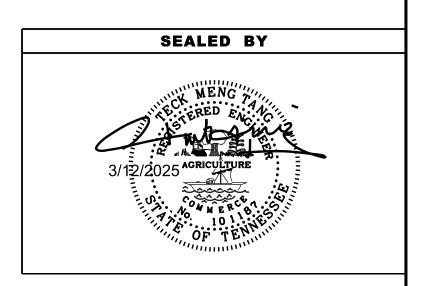

STATE OF TENNESSEE DEPARTMENT OF TRANSPORTATION

TABULATED QUANTITIES


RIGHT - OF - WAY NOTES

- (1) IT IS INTENDED THAT ALL BUILDINGS AND/OR PORTIONS OF BUILDINGS THAT ARE WITHIN THE PROPOSED RIGHT-OF-WAY AND/OR EASEMENT LINES FOR THE PROJECT BE REMOVED THEREFROM IN THE PROCESS OF RIGHT-OF-WAY ACQUISITION. IF ANY SUCH BUILDINGS OR IMPROVEMENTS ARE NOT REMOVED IN THE COURSE OF RIGHT-OF-WAY ACQUISITION, THE CIVIL ENGINEERING MANAGER 2, DESIGN DIVISION IS TO BE NOTIFIED IN SUFFICIENT TIME TO PERMIT HAVING SUCH REMOVALS DESIGNATED AS A PART OF THE CONSTRUCTION CONTRACT.
- (2) ALL RAMPS MUST CONFORM TO THE DEPARTMENT'S "POLICY ON FINANCING CONSTRUCTION OF PUBLIC ROAD INTERSECTIONS AND DRIVEWAYS ON HIGHWAY RESURFACING, RECONSTRUCTION AND CONSTRUCTION PROJECTS ON NEW LOCATIONS", THE MANUAL ON RULES AND REGULATIONS FOR CONSTRUCTING DRIVEWAYS ON STATE HIGHWAY RIGHT-OF-WAY, STANDARD DRAWING RP-R-1, AND OTHER ACCEPTED DESIGN AND SAFETY STANDARDS.
- (3) EXISTING PAVED DRIVEWAY PER TRACT REMAINDER WILL BE REPLACED IN KIND TO A TOUCHDOWN POINT.
- (4) WHERE THE EXISTING DRIVEWAY IS UNPAVED AND THE PROPOSED DRIVEWAY EXCEEDS 7 PERCENT IN GRADE, EACH DRIVEWAY WILL BE PAVED TO A TOUCHDOWN POINT OR UNTIL THE GRADE IS LESS THAN 7 PERCENT.
- (5) WHERE THE EXISTING DRIVEWAY IS UNPAVED AND THE PROPOSED DRIVEWAY IS LESS THAN 7 PERCENT IN GRADE, EACH DRIVEWAY WILL BE PAVED A SHOULDER WIDTH FROM THE EDGE OF PAVEMENT AND THE REMAINDER OF THAT DRIVEWAY REPLACED IN KIND TO A TOUCHDOWN POINT.
- (6) ANY NECESSARY PAVING OF DRIVEWAYS WILL BE DONE DURING PAVING OPERATIONS ON THE MAIN ROADWAY.
- (7) TRACT REMAINDERS NOT HAVING AN EXISTING DRIVEWAY WILL BE PROVIDED ONE 50-FOOT OPENING IN THE ACCESS CONTROL FENCE AND A DRIVEWAY WILL BE CONSTRUCTED UNLESS ACCESS IS PROVIDED FROM AN INTERSECTING ROAD OR BASED ON PHYSICAL CONDITIONS AND/OR CONFLICTS WITH OTHER DESIGN CONSIDERATIONS WHICH PREVENT AN ACCESS OPENING. PAVING OF THESE NEW DRIVEWAYS WILL BE IN ACCORDANCE TO THE 7 PERCENT CRITERIA PREVIOUSLY MENTIONED FOR EXISTING DRIVEWAYS.
- (8) NEW DRIVEWAYS PROVIDED IN THE PLANS WILL BE PAVED BASED ON THE 7 PERCENT CRITERIA. THOSE 7 PERCENT OR STEEPER IN GRADE WILL BE PAVED AND THOSE FLATTER THAN 7 PERCENT WILL BE COVERED WITH BASE STONE.
- (9) ON PROJECTS WITH CURB AND GUTTER THAT ARE ON STATE ROUTES, IT WILL BE THE RESPONSIBILITY OF THE OWNER TO SECURE A PERMIT. AFTER THE PERMIT HAS BEEN GRANTED, THE DEPARTMENT WILL CONSTRUCT THE DRIVEWAY OR FIELD ENTRANCE THROUGH THE CURB AND SIDEWALK, PROVIDED THE CURB AND SIDEWALK HAVE NOT BEEN CONSTRUCTED. IT WILL BE THE RESPONSIBILITY OF THE PROPERTY OWNER TO CONSTRUCT THE DRIVEWAY OR FIELD ENTRANCE FROM BACK OF SIDEWALK TO TOUCHDOWN POINT FOR ANY ADDITIONAL DRIVEWAYS OR FIELD ENTRANCES OTHER THAN THOSE PROVIDED IN THE PLANS.
- (10) ON NON-STATE ROUTES, ADDITIONAL DRIVEWAYS AND FIELD ENTRANCES OTHER THAN THOSE PROVIDED IN THE PLANS SHALL REQUIRE A PERMIT ONLY IF THE LOCAL AGENCY SPECIFIES THE NEED FOR THAT PERMIT.

UTILITY

- (1) THE LOCATIONS OF UTILITIES SHOWN WITHIN THESE PLANS ARE APPROXIMATE ONLY. THE SURVEYOR HAS NOT PHYSICALLY LOCATED THE UNDERGROUND UTILITIES. ABOVE GRADE AND UNDERGROUND UTILITIES SHOWN WERE TAKEN FROM VISIBLE APPURTENANCES AT THE SITE, PUBLIC RECORDS, AND/OR MAPS PREPARED BY OTHERS. THEREFORE, RELIANCE UPON THE TYPE, SIZE, AND LOCATION OF UTILITIES SHOWN SHOULD BE DONE SO WITH THIS CIRCUMSTANCE CONSIDERED. DETAILED VERIFICATION OF EXISTENCE, LOCATION, AND DEPTH SHOULD ALSO BE MADE PRIOR TO ANY DECISION RELATIVE THERETO IS MADE. AVAILABILITY AND COST OF SERVICE SHOULD BE CONFIRMED WITH THE APPROPRIATE UTILITY COMPANY. IN TENNESSEE. IT IS A REQUIREMENT, PER "THE UNDERGROUND UTILITY DAMAGE PREVENTION ACT", THAT ANYONE WHO ENGAGES IN EXCAVATION MUST NOTIFY ALL KNOWN UNDERGROUND UTILITY OWNERS. NO LESS THAN THREE (3) OR NOT MORE THAN TEN (10) WORKING DAYS PRIOR TO THE DATE OF THEIR INTENT TO EXCAVATE AND ALSO TO AVOID ANY POSSIBLE HAZARD OR CONFLICT. NOTIFICATION BY CALLING THE TENNESSEE ONE CALL SYSTEM, INC., AT 1-800-351-1111 AS REQUIRED BY TCA 65-31-106 WILL BE REQUIRED.
- UNLESS OTHERWISE NOTED, ALL UTILITY ADJUSTMENTS WILL BE PERFORMED BY THE UTILITY OR ITS REPRESENTATIVE. THE CONTRACTOR AND UTILITY OWNERS WILL BE REQUIRED TO COOPERATE WITH EACH OTHER IN ORDER TO EXPEDITE THE WORK REQUIRED BY THIS CONTRACT. ON CONTRACTS WHERE CONSTRUCTION STAKES, LINES, AND GRADES ARE CONTRACT ITEMS, THE CONTRACTOR WILL BE REQUIRED TO PROVIDE RIGHT-OF-WAY OR SLOPE STAKES, DITCH OR STREAM BED GRADES, OR OTHER ESSENTIAL SURVEY STAKING TO PREVENT CONFLICTS WITH THE HIGHWAY CONSTRUCTION. FREQUENTLY, THIS WILL BE REQUIRED AS THE FIRST ITEM OF WORK AND AT ANY LOCATION ON THE PROJECT DIRECTED BY THE ENGINEER.
- (3) THE CONTRACTOR WILL PROVIDE ALL NECESSARY PROTECTIVE MEASURES TO SAFEGUARD EXISTING UTILITIES FROM DAMAGE DURING CONSTRUCTION OF THIS PROJECT. IN THE EVENT THAT SPECIAL EQUIPMENT IS REQUIRED TO WORK OVER AND AROUND THE UTILITIES, THE CONTRACTOR WILL BE REQUIRED TO FURNISH SUCH EQUIPMENT. THE COST OF PROTECTING UTILITIES FROM DAMAGE AND FURNISHING SPECIAL EQUIPMENT WILL BE INCLUDED IN THE PRICE BID FOR OTHER ITEMS OF CONSTRUCTION.
- (4) PRIOR TO SUBMITTING HIS BID, THE CONTRACTOR WILL BE SOLELY RESPONSIBLE FOR CONTACTING OWNERS OF ALL AFFECTED UTILITIES IN ORDER TO DETERMINE THE EXTENT TO WHICH UTILITY RELOCATIONS AND/OR ADJUSTMENTS WILL HAVE UPON THE SCHEDULE OF WORK FOR THE PROJECT. WHILE SOME WORK MAY BE REQUIRED 'AROUND' UTILITY FACILITIES THAT WILL REMAIN IN PLACE, OTHER UTILITY FACILITIES MAY NEED TO BE ADJUSTED CONCURRENTLY WITH THE CONTRACTOR'S OPERATIONS. ADVANCE CLEAR CUTTING MAY BE REQUIRED BY THE ENGINEER AT ANY LOCATION WHERE CLEARING IS CALLED FOR IN THE SPECIFICATIONS AND CLEAR CUTTING IS NECESSARY FOR A UTILITY RELOCATION. ANY ADDITIONAL COST WILL BE INCLUDED IN THE UNIT PRICE BID FOR THE CLEARING ITEM SPECIFIED IN THE PLANS.
- (5) THE CONTRACTOR SHALL NOTIFY EACH INDIVIDUAL UTILITY OWNER OF HIS PLAN OF OPERATION IN THE AREA OF THE UTILITIES. PRIOR TO COMMENCING WORK, THE CONTRACTOR SHALL CONTACT THE UTILITY OWNERS AND REQUEST THEM TO PROPERLY LOCATE THEIR RESPECTIVE UTILITY ON THE GROUND. THIS NOTIFICATION SHALL BE GIVEN AT LEAST THREE (3) BUSINESS DAYS PRIOR TO COMMENCEMENT OF OPERATIONS AROUND THE UTILITY IN ACCORDANCE WITH TCA 65-31-106. NOTIFICATION BY CALLING THE TENNESSEE ONE CALL SYSTEM, INC AT 1-800-351-1111 WILL BE REQUIRED.


		l	UTILITY OV	VNERS				
UTILITY	OWNER	EMAIL	PHONE NO.	CONTACT	ADDRESS	CITY	STATE	ZIP CODE
	CENTURY LINK/LEVEL 3/LUMEN	russ.wheat@lumen.com	803-832-2576	RUSS WHEAT	520 WHALEY ST.	COLUMBIA	sc	29201
	AT&T	dp7607@att.com	901-488-2359	DANIEL R. POTTS	315 E. COLLEGE ST	JACKSON	TN	38301
COMMUNICATIONS	COMCAST	karen_price@comcast.com	O: 901-623-7463 C: 901-508-0920	J KAREN PRICE	2650 MOUNT MORIAH RD.	MEMPHIS	TN	38115
	VERIZON/XO COMMUNICATIONS	robert.stafford@verizon.com	901-239-2912	ROBERT STAFFORD	5127 TRUSE RD.	MEMPHIS	TN	38117
	ZAYO	rusty.perdieu@zayo.com	706-889-6967	RUSTY PERDIEU	2030 POWERS FERRY RD. SE STE 360	ATLANTA	GA	30339
GAS								
WATER ELEC. TRANSMISSION	MLGW	adabney@mlgw.org	901-528-4186	ANGEL BAILEY	220 S. MAIN ST.	MEMPHIS	TN	38103
								+
SEWER	CITY OF MEMPHIS	faraedoon.qaladize@memphistn.gov	901-576-6725 901-636-6971	FARAEDOON QALADIZE	125 N. MAIN ST, ROOM 639	MEMPHIS	TN	38103
TRAFFIC SIGNAL	CITY OF MEMPHIS	randall.tatum@memphistn.gov	901-576-6710	RANDALL TATUM	125 N. MAIN ST. ROOM 668	MEMPHIS	TN	38103
TRAFFIC SIGNAL	CITY OF MEMPHIS	randall.tatum@memphistn.gov	901-576-6710	RANDALL TATUM	125 N. MAIN ST. ROOM 668	MEMPHIS	TN	-

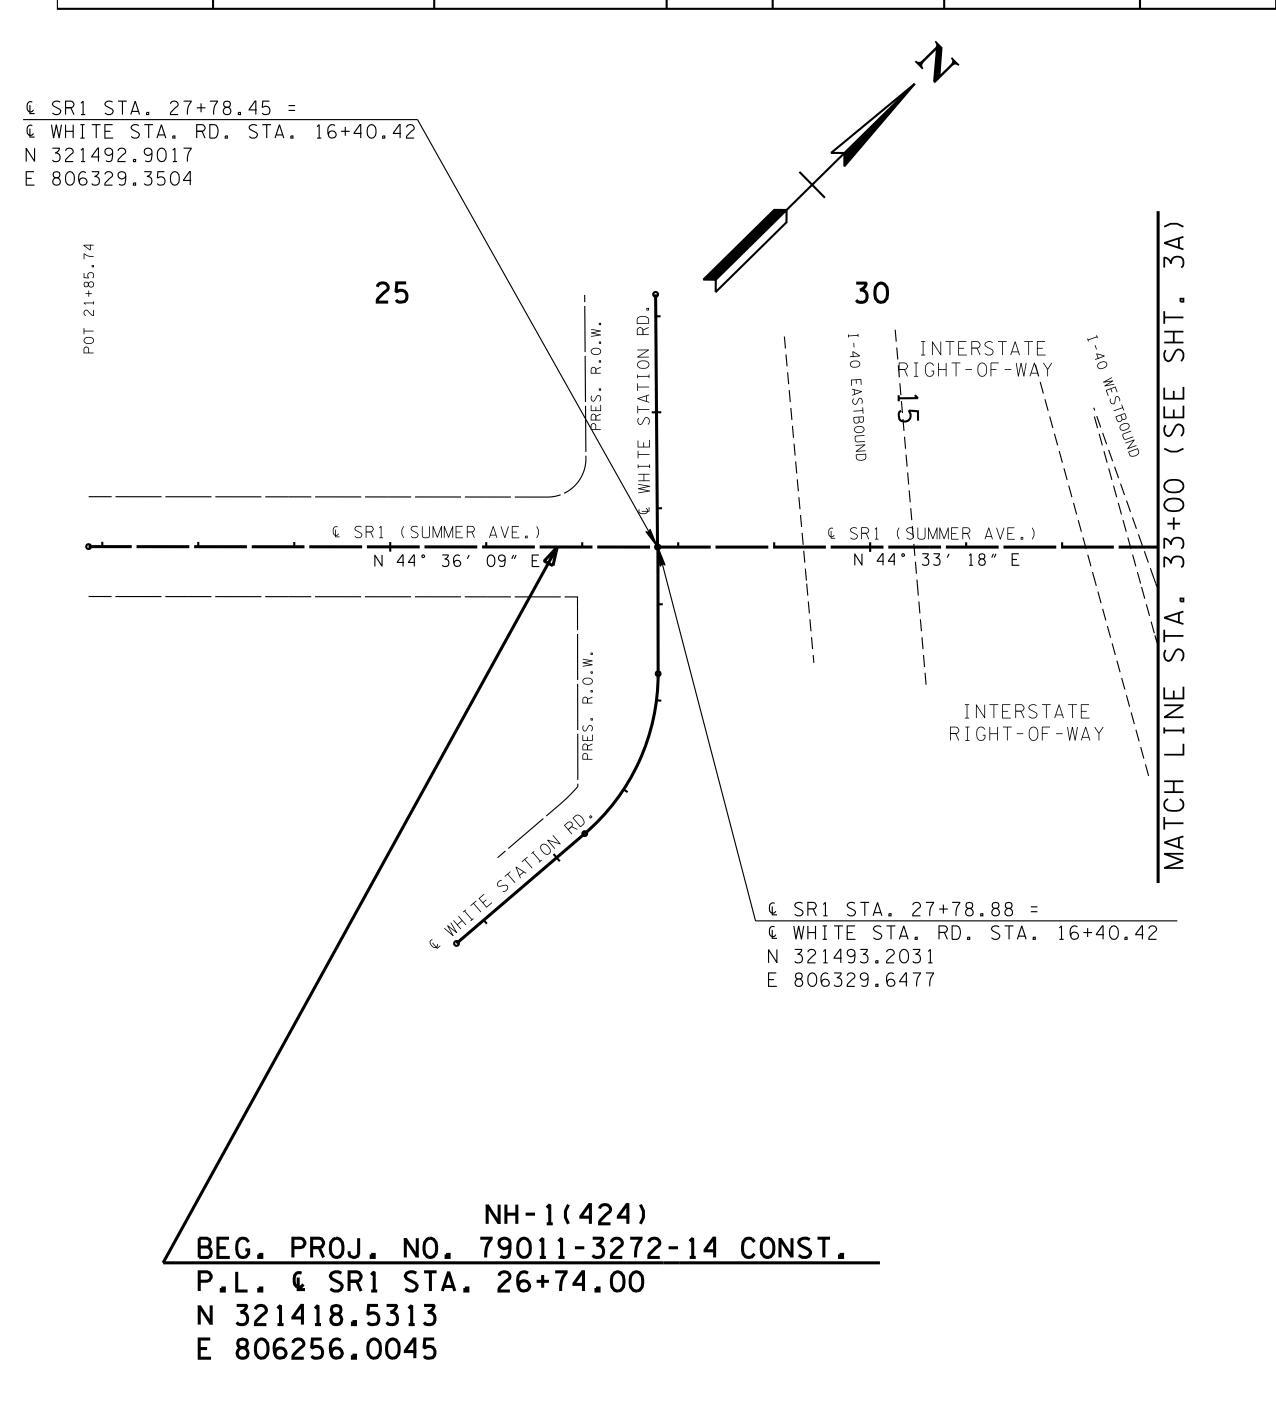

TYPE	YEAR	PROJECT NO.	SHEET NO.
ROW	1999	STP-1(93)	3
PS&E	2025	NH-1(424)	3

REV. 3-12-25: UPDATED UTILITIES CONTACT

SEALED BY

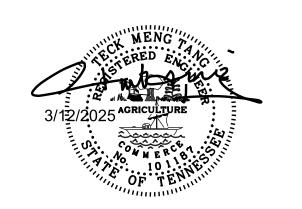

COORDINATES ARE NAD 83(1995), ARE DATUM ADJUSTED BY THE FACTOR OF 1.00006 AND TIED TO THE TGRN. ALL ELEVATIONS ARE REFERENCED TO THE NAVD 1988.

STATE OF TENNESSEE
DEPARTMENT OF TRANSPORTATION

RIGHT-OF-WAY NOTES, UTILITY NOTES, UTILITY OWNERS, & PROPERTY MAP BEG. PROJ. TO STA. 33 +00 SCALE: 1"=100'

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TRAFFIC CONTRO	L SIGN	SCHEDULE					
SIGN TYPE	MUTCD NUMBER	SIZE AREA	UN I T	PHASE ONE	PHASE TWO	PHASE THREE	TOTAL
Summer Ave East	D3-1	40" X 12" 3.33 s.f.	S.F.	-	-	3.33	3.33
STOP	R1-1	30″ X 30″ 6.25 s.f.	S.F.	-	-	6.25	6.25
VIELD	R1-2	36" X 36" X 36" 3.9 s.f.	S.F.	-	-	3.9	3.9
SIDEWALK	R9-9	24" X 12" 2 s.f.	S.F.	-	16	18	18
SIDEWALK CLOSED USE OTHER SIDE	R9-10	24″ X 12″ 2 s.f.	S.F.	6	4	2	6
RIGHT LANE MUST TURN RIGHT	R3-7R	30″ X 30″ 6.25 s.f.	S.F.	-	25	31.25	31.25
LEFT LANE MUST TURN LEFT	R3-7L	30″ X 30″ 6.25 s.f.	S.F.	-	18.75	18.75	18.75
	W1-4L	30″ X 30″ 6.25 s.f.	S.F.	-	18.75	6.25	18.75
(77)	W1-4BL	30″ X 30″ 6.25 s.f.	S.F.	-	6.25	12.5	12.5
(\$\$)	W1-4BR	30″ X 30″ 6.25 s.f.	S.F.	-	-	6.25	6.25
	W4-2LC	36″ X 36″ 9 s.f.	S.F.	-	9	-	9
	W4-2RC	36″ X 36″ 9 s.f.	S.F.	27	9	18	18
	W6-3	36" X 36" 9 s.f.	S.F.	-	36	18	36
35 MPH	W13-1	18" X 18" 2.25 s.f.	S.F.	6.75	13.5	11.25	13.5
ROAD WORK AHEAD	W20-1	36″ X 36″ 9 s.f.	S.F.	27	90	90	90
ROAD WORK 500 FT	W20-1F	36″ X 36″ 9 s.f.	S.F.	-	18	18	18
ROAD WORK 1000 FT	W20-1F	36″ X 36″ 9 s.f.	S.F.	-	18	18	18
ROAD WORK 1500 FT	W20-1F	36″ X 36″ 9 s.f.	S.F.	18	-	-	18
ROAD WORK 1/2 MILE	W20-1M	36″ X 36″ 9 s.f.	S.F.	-	18	18	18


ITEM 712-06: 472 S.F.

	ITEM				QUANTITY	7	T		M.U.T.C.D.	
	NO.	DESCRIPTION	UNIT	PHASE I		PHASE III	TOTAL	SIZE	NO.	REMARKS
	303-01	MINERAL AGGREGATE, TYPE A BASE, GRADING D	TON	3289	-	-	3289			
	303-10.01	MINERAL AGGREGATE (SIZE 57)	TON	322	-	-	322			
	307-01.21	ASPHALT CONCRETE MIX (PG70-22)(BPMB-HM) GRADING A-S	TON	573	-	-	573			
	307-02.08	ASPHALT CONCRETE MIX (PG70-22) (BPMB-HM) GRADING B-M2	TON	460	-	-	460			
	402-01	BITUMINOUS MATERIAL FOR PRIME COAT (PC)	TON	7	-	-	7			
	402-02	AGGREGRATE COVER MATERIAL (PC)	TON	28	-	-	28			
	403-01	BITUMINOUS MATERIAL FOR TACK COAT (TC)	TON	4	-	-	4			
	411-02.10	ACS MIX (PG70-22) GRADING D	TON	253	-	-	253			
	607-05.02	24" CONCRETE PIPE CULVERT (CLASS III)	L.F.	14	_	_	14			
\vdash	621-03.02	18" TEMPORARY DRAINAGE PIPE	L.F.	582	-	-	582			
-	712-01	TRAFFIC CONTROL	LS	1	1	1	1		1 1	
- ⊢	712-02.02	INTERCONNECTED PORTABLE BARRIER RAIL	L.F.	-	1080	9405	19565			
\vdash	712-02.60	TEMPORARY WORK ZONE CRASH CUSHION (MASH TL-3)	E.A.	-	4	50	54			
\vdash	712-04.50	BARRIER RAIL DELINEATOR	E.A.	-	55	7	200			
-	712-04.01	FLEXIBLE DRUMS (CHANNELIZING)	EA.	222	721	237	721			
. -	712-05.01	WARNING LIGHTS (TYPE A)	EA.		28	23	28			
\vdash	712-05.03	WARNING LIGHTS (TYPE C)	EA.		47	-	47			
	712-06	SIGNS (CONSTRUCTION)	S.F.				1048			
	712-07.02	TEMPORARY BARRICADES (TYPE II)	L.F.		60	65	65			
- -	712-07.03	TEMPORARY BARRICADES (TYPE III)	L.F.	-	142	4249	4249			
	712-08.03	ARROW BOARD (TYPE C)	EA.	3	3	2	3			
	712-09.02	REMOVABLE PAVEMENT MARKING (8" BARRIER LINE)	L.F.	_	_	14664	14664		_	
	712-09.03	REMOVABLE PAVEMENT MARKING (CHANNELIZATION STRIPING)	S.Y.	_	_	31	31		+	
<u> </u>	712-09.04	REMOVABLE PAVEMENT MARKING (STOP LINE)	L.F.	-	_	314	314		+ +	
	712-09.05	REMOVABLE PAVEMENT MARKING (ARROW)	EA.	-		26	26		+ +	
	712-09.08	REMOVABLE PAVEMENT MARKING (6" LINE)	- L.F.	-	_	26467	26467		+ +	
	713-16.01	CHANGEABLE MESSAGE SIGN UNIT	E.A.			11	11		+ +	
\vdash	716-01.07	TEMPORARY RAISED PAVEMENT MARKER, YELLOW	E.A.	-	53	46	99		+ +	
- ⊢	716-05.02	PAINTED PAVEMENT MARKING (8" LINE)	L.F.	6694	15289	-	21983		1	
\vdash	716-05.04	PAINTED PAVEMENT MARKING (CHANNELIZATION STRIPING)	S.Y.	-	50	-	50		+	
- ⊢	716-05.05	PAINTED PAVEMENT MARKING (STOP LINE)	L.F.	-	386		386		 	
	716-05.06	PAINTED PAVEMENT MARKING (TURN LANE ARROW)	E.A.	-	29	-	29		 	
⊢	716-05.20	PAINTED PAVEMENT MARKING (6" LINE)	LF	-	37185	-	37185		1	
	801-01.07 801-02.15	TEMPORARY SEEDING (WITH MULCH) FERTILIZER	UNIT	47 1	-	-	94		1	FACTOR OF 2
\vdash	801-02.15	WATER (SEEDING & SODDING)	M.G.	4	-	-	4		+ +	
\vdash	801-03	SEED (SUPPLEMENTAL APPLICATION)	L.B.	11	-	-	22		+ +	FACTOR OF 2
		FERTILIZER (SUPPLEMENTAL APPLICATION)	TON			 	1		+	

FOOTNOTES

- 1. ADDITIONAL 10160 L.F. OF PBR IS PROVIDED TO REMOVE EXISTING WATERLINE & MAINTAINING DRIVEWAYS ACCESS DURING PHASE III
- 2. ADDITIONAL 330 BARRELS ARE FOR MAINTAINING DRWIVEWAY ACCESS DURING PHASE II
- 3. ADDITIONAL 4032 LF OF TEMPORARY BARRICADES (TYPE III) FOR MAINTAINING DRIVEWAY ACCESS DURING PHASE III
- ADDITIONAL 42 TEMPORARY ATTENUATORS ARE FOR MAINTAINING DRIVEWAY ACCESS DURING PHASE III
 ADDITIONAL QUANTITY FOR INTERSECTION DETOURS DURING PHASE III
- -ITEM 712-04.01: 40 EA.
- -ITEM 712-05.01: 12 EA.
- -ITEM 712-06: 432 S.F.
- -ITEM 712-06: 432 3.F.
- -ITEM 713-16.01: 11 EA.


TRAFFIC CONTROL SIGN SCHEDULE							
SIGN TYPE	MUTCD NUMBER	SIZE AREA	UNIT	PHASE ONE	PHASE TWO	PHASE THREE	TOTAL
LEFT LANE CLOSED AHEAD	W20-5L	36″ X 36″ 9 s.f.	S.F.	-	9	-	9
RIGHT LANE CLOSED AHEAD	W20-5R	36″ X 36″ 9 s.f.	S.F.	-	18	27	27
RIGHT LANE CLOSED 1000 FT	W20-5R	36″ X 36″ 9 s.f.	S.F.	18	-	-	18
END ROAD WORK	G20-2	36" X 18" 4.5 s.f.	S.F.	22.5	54	54	54

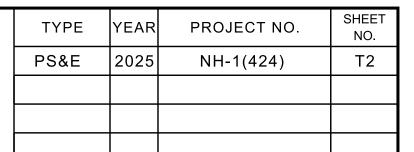

REV. 3-12-25: REVISED ITEM NO. 712-06, 712-09.02, 712-09.03,712-09.04, 712-09.05 & 712-09.08.

ADDED ITEM NO. 713-16.01, 716-05.02, 716-05.04, 716-05.05, 716-05.06 & 716-05.20.

REMOVED 716-02.08

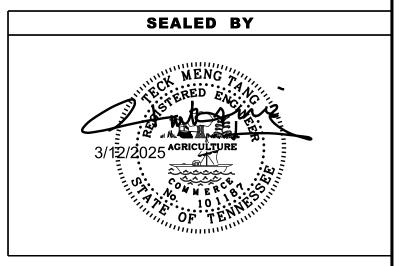

STATE OF TENNESSEE
DEPARTMENT OF TRANSPORTATION

TRAFFIC PHASING NOTES, LEGEND AND TABULATION

PHASE 2

- 1. PHASE 2 INVOLVES THE CONSTRUCTION OF THE PROPOSED EAST BOUND ROADWAY (GENERALLY, THE SOUTHERN HALF OF SUMMER AVE), SOUTH BOUND OF BARTLETT ROAD/SHELBY OAKS DRIVE, SUMMER TREES DRIVE, SOUTH BOUND OF NORTH SYCAMORE VIEW ROAD, AND THE FULL DEPTH PAVEMENTS OF SOUTH SYCAMORE VIEW ROAD.
- 2. TRAFFIC SHALL BE MAINTAINED ON THREE 11-FOOT TRAFFIC LANES (ONE LANE IN EACH DIRECTION AND A CENTER TURN LANE) IN THE NORTHERN HALF OF SUMMER AVENUE. FIVE TRAFFIC LANES (TWO IN EACH DIRECTION AND A CENTER TURN LANE) SHALL BE MAINTAINED ON SYCAMORE VIEW ROAD. ONE OF THE TWO LEFT TURN LANES IN RAMP SHALL BE REMOVED TO ACCOMMODATE SUMMER AVENUE TRAFFIC LANES. MAINTAIN TWO LANES ALONG THE BRIDGES AT WOLF RIVER & FLETCHER CREEK. SUMMER TREES DRIVE WILL BE CLOSED WITH PROVIDED DETOUR.
- 3. PRIOR TO ANY LANE CLOSURE AND SHIFTING OF TRAFFIC, CONTRACTOR SHALL REMOVE ANY CONFLICTING SIGNS AND PAVEMENT MARKINGS, AND INSTALL NEW TEMPORARY TRAFFIC CONTROL ITEMS SUCH AS ADVANCE WARNING SIGNS, ETC. AND TEMPORARY PAVEMENT MARKINGS IN ACCORDANCE TO THE PHASE 2 TCP AS SHOWN IN THE PLANS. THE COST OF REMOVAL OF SIGNS & PAVEMENT MARKINGS SHALL BE INCLUDED IN THE COST OF THE ITEM # 712-01, TRAFFIC CONTROL.
- 4. DUE TO THE LANE CLOSURES AND LANE SHIFTS, TRAFFIC SIGNAL HEAD LOCATIONS AT WHITE STATION AND RAMP-A SHALL BE ADJUSTED TO ALIGN WITH THE TEMPORARY LANES. TEMPORARY TRAFFIC SIGNAL SHALL BE INSTALLED AT BARTLETT/SHELBY OAKS AND SYCAMORE VIEW. THE TIMING OF THE TRAFFIC SIGNALS SHALL ALSO BE ADJUSTED. CONTRACTOR SHALL CONTACT THE TRAFFIC ENGINEER WITH THE CITY OF MEMPHIS, RANDALL TATUM AT 901-636-6710 FOR FURTHER GUIDANCE.
- 5. HAUL ROADS SHALL BE CONSTRUCTED AS NEEDED.
- 6. THE CONTRACTOR SHALL INSTALL ADDITIONAL SIGNS OR PAVEMENT MARKINGS AS DIRECTED BY THE ENGINEER. COST OF ANY ADDITIONAL ITEMS SHALL BE PAID PER THE UNIT COST OF THE ITEMS AS BIDDED.
- 7. EXISTING SIDEWALKS IN THE WORK ZONE SHALL BE CLOSED AND PEDESTRIANS TRAFFIC SHALL BE DIRECTED TO ALTERNATIVE SIDEWALKS AS SHOWN IN THE PLANS. PEDESTRIAN SIGNS SHALL BE MOUNTED ON 5 FT TEMPORARY BARRICADE (TYPE II). MID-BLOCK CROSSING, TEMPORARY ACCESS OR DETOUR WILL NOT BE PROVIDED DUE TO UTILITIES RELOCATIONS IN THE WORK ZONE AND NO EXISTING PEDESTRIAN ACCESS PRIOR TO THIS IMPROVEMENT.

PHASE 3 & 3A

- PHASE 3 INVOLVES THE CONSTRUCTION OF THE PROPOSED WEST BOUND ROADWAY (GENERALLY,
 THE NORTHERN HALF OF SUMMER AVE), FRONTAGE ROAD, NORTH BOUND BARTLETT ROAD/SHELBY
 OAKS DRIVE, AND THE NORTH BOUND NORTH SYCAMORE VIEW ROAD.
- 2. PHASE 3 ALSO INVOLVES THE CONSTRUCTION OF THE PROPOSED MLG&W WATER FACILITY AND REMOVAL OF THE EXISTING WATER FACILITY AS SHOWN IN THE MLG&W WATER RELOCATION PLANS.

 ANY SUB-PHASES NEEDED FOR INSTALLATION (INCLUDING BUT NOT LIMITED TO INSTALLATION OF THE DISTRIBUTION LINES, CONNECTION TO NEW MAIN, SERVICE CONNECTIONS, ETC.),

 REMOVAL OF THE EXISTING WATER FACILITY, AND WORK ACROSS INTERSECTING ROADS,

 SHALL BE APPROVED BY THE ENGINEER, INCLUDING THE TIMING OF WORK FOR THE SUB-PHASES.

 ALL COSTS ASSOCIATED WITH THE WATER RELOCATION WORK (REMOVAL, INSTALLATION, AND SITE WORK)


 SHALL BE INCLUDED IN THE UNIT COST OF THE WATER RELOCATION ITEMS.

 PHASE 3A* IT IS ANTICIPATED THAT BARTLETT ROAD AND SYCAMORE VIEW, NORTH OF SUMMER AVE.,


 WILL HAVE INTERMITTENT WEEKEND CLOSURES, AS NOTED IN SP 108B, FOR WATER RELOCATION WORK.

 SEE PHASE 3A DETAILS ON SHEETS TSE-1, T5J-1, AND T5K-1. ALSO SEE THE PROPOSED DETOUR MAPS


 SHEETS T2D THRU T2G. NOTE THAT THE TEMPORARY SIGNALS WILL NEED TO BE ADJUSTED DURING THE CLOSURES.
- 3. TRAFFIC SHALL BE MAINTAINED ON THREE 11-FOOT TRAFFIC LANES (ONE LANE IN EACH DIRECTION AND A CENTER TURN LANE) IN THE NORTHERN HALF OF SUMMER AVENUE. SIX LANES SHALL REMAIN OPEN TO TRAFFIC ON SYCAMORE VIEW ROAD (TWO IN EACH DIRECTION, A CENTER TURN LANE AND AN AUXILIARY LANE FOR RIGHT TURN OR THRU LANE). ONE OF THE TWO LEFT TURN LANES ON RAMP A SHALL BE REMOVED TO ACCOMMODATE SUMMER AVENUE TRAFFIC LANES. MAINTAIN TWO LANES ALONG THE BRIDGE AT WOLF RIVER.
- 4. PRIOR TO ANY LANE CLOSURE AND SHIFTING OF TRAFFIC, CONTRACTOR SHALL REMOVE ANY CONFLICTING SIGNS AND PAVEMENT MARKINGS, AND INSTALL NEW TEMPORARY TRAFFIC CONTROL ITEMS SUCH AS ADVANCE WARNING SIGNS, ETC. AND TEMPORARY PAVEMENT MARKINGS IN ACCORDANCE TO THE PHASE 3 TCP AS SHOWN IN THE PLANS. THE COST OF REMOVAL OF SIGNS & PAVEMENT MARKINGS SHALL BE INCLUDED IN THE COST OF THE ITEM # 712-01, TRAFFIC CONTROL.
- 5. DUE TO THE LANE CLOSURES AND LANE SHIFTS, TRAFFIC SIGNAL HEAD LOCATIONS AT WHITE STATION AND RAMP-A SHALL BE ADJUSTED TO ALIGN WITH THE TEMPORARY LANES. TEMPORARY TRAFFIC SIGNAL SHALL BE INSTALLED AT BARTLETT/SHELBY OAKS AND SCYAMORE VIEW. THE TIMING OF THE TRAFFIC SIGNALS SHALL ALSO BE ADJUSTED. CONTRACTOR SHALL CONTACT THE TRAFFIC ENGINEER WITH THE CITY OF MEMPHIS, RANDALL TATUM AT 901-636-6710 FOR FURTHER GUIDANCE.
- HAUL ROADS SHALL BE CONSTRUCTED AS NEEDED.
- 7. PERFORM MILLING AND OVERLAYING IN PLACES AS SHOWN IN THE PLANS, AND FINAL SURFACE PAVING.
- 8. THE CONTRACTOR SHALL INSTALL ADDITIONAL SIGNS OR PAVEMENT MARKINGS AS DIRECTED BY THE ENGINEER. COST OF ANY ADDITIONAL ITEMS SHALL BE PAID PER THE UNIT COST OF THE ITEMS AS BIDDED.
- 9. REMOVE ALL TEMPORARY TRAFFIC CONTROL RELATED PAVEMENT MARKINGS AND INSTALL PERMAMENT PAVEMENT MARKINGS PRIOR TO OPENING THE NEW ROADWAY UP TO TRAFFIC.
- 10. EXISTING SIDEWALKS IN THE WORK ZONE SHALL BE CLOSED AND PEDESTRIANS TRAFFIC SHALL BE DIRECTED TO ALTERNATIVE SIDEWALKS AS SHOWN IN THE PLANS. PEDESTRIAN SIGNS SHALL BE MOUNTED ON 5 FT TEMPORARY BARRICADE (TYPE II). MID-BLOCK CROSSING, TEMPORARY ACCESS OR DETOUR WILL NOT BE PROVIDED DUE TO UTILITIES RELOCATIONS IN THE WORK ZONE AND NO EXISTING PEDESTRIAN ACESS PRIOR TO THIS IMPROVEMENT.

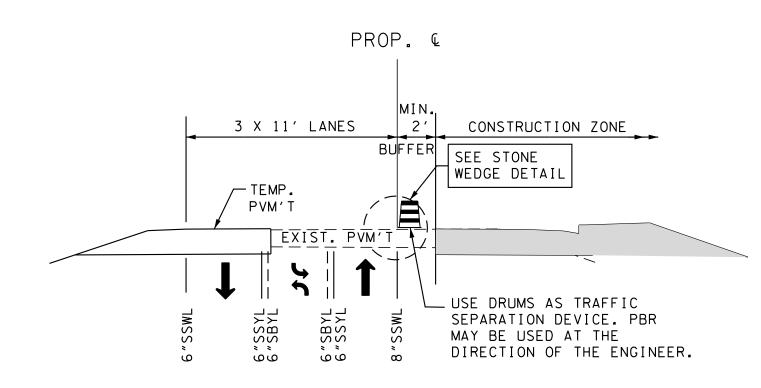


PHASE 2 CONSTRUCTION (NTS)

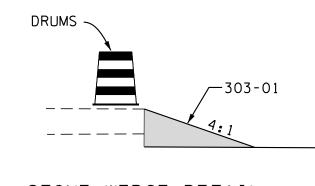


STONE WEDGE DETAIL
(N.T.S.)

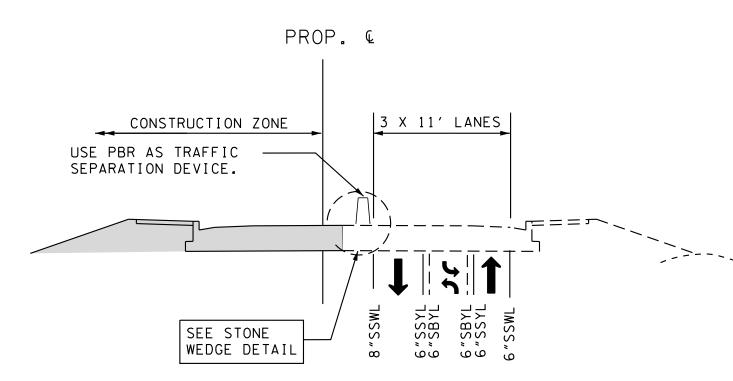


PHASE 3 CONSTRUCTION (NTS)

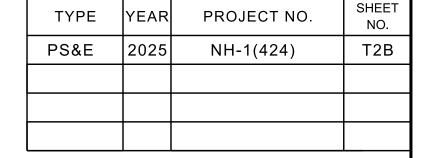

REV. 3-12-25: REVISED NOTE (2) OF PHASE 3 TO INCLUDE ROAD CLOSED FOR BARTLETT ROAD & NORTH SYCAMORE VIEW AS PART OF PHASE 3A.

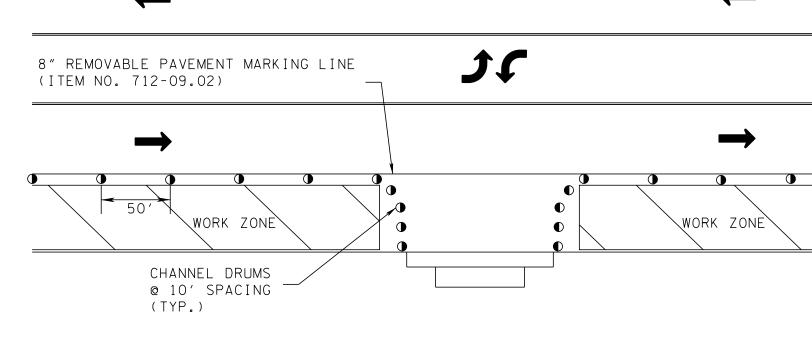

DRIVEWAY ACCESS DETAIL (NTS)

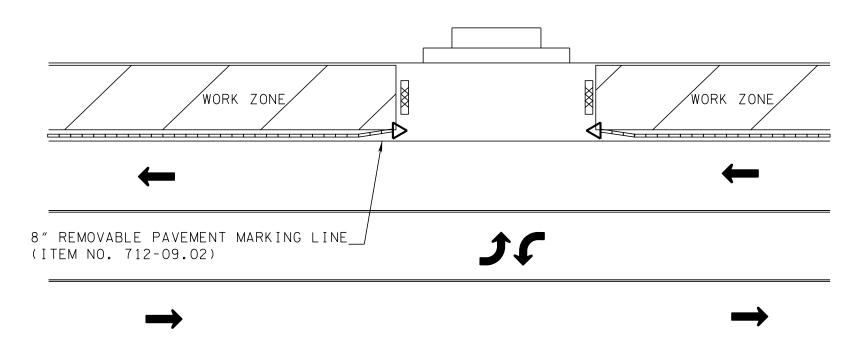

DRIVEWAY ACCESS DETAIL (NTS)

TO BE USED WITH


PORTABLE BARRIER WALL

TEMPORARY SIGNALS NOTES (PER STD DWG T-SG-11)

WHEN CONSTRUCTION OPERATIONS AND PHASING REQUIRE THE REMOVAL OR RELOCATION OF EXISTING SIGNAL EQUIPMENT (I.E., SIGNAL SUPPORT, BASE-MOUNTED CONTROLLERS), THE CONTRACTOR MAY USE THE FOLLOWING METHODS TO MAINTAIN SIGNALIZATION:


- 1. THE CONTRACTOR MAY RELOCATE EXISTING EQUIPMENT.
- 2. THE CONTRACTOR MAY USE PROPOSED EQUIPMENT. EQUIPMENT SUCH AS SIGNAL SUPPORTS, BASE-MOUNTED CONTROLLERS, PULL BOXES, AND CONDUIT SHALL BE INSTALLED IN THE PROPOSED FINAL LOCATION AND AT FINAL GRADES AND SHALL NOT BE RELOCATED. IF PROPOSED SPAN WIRE AND/OR SIGNAL CABLES ARE USED WITH TEMPORARY SUPPORTS, SUFFICIENT SLACH SHALL BE LEFT TO ATTACH TO FINAL SUPPORTS AND FOR FINAL SIGNAL HEAD ALIGNMENT OR FOR REPOSITIONING EQUIPMENT DURING CONSTRUCTION PHASING. IF CONDITIONS MAKE IT IMPRACTICAL TO LEAVE SLACK IN SPAN WIRE, THE PROPOSED SPAN WIRE MAY BE OVERRUN, AS APPROVED BY THE ENGINEER. (IN PROJECTS WHERE FINAL SUPPORTS ARE PROVIDED IN THE PLANS, TEMPORARY SPAN WIRE WILL ALSO BE PROVIDED IN THE PLANS.)
- 3. THE CONTRACTOR MAY SUPPLY AND USE TEMPORARY EQUIPMENT, AS PROVIDED FOR IN THE PLANS OR AT HIS OWN DISCRETION. THIS MATERIAL AND EQUIPMENT, WHILE NOT REQUIRED TO BE NEW, SHALL BE IN GOOD CONDITION AND READY FOR USE. IF THE CONTROLLER THAT IS NOT NEW, CERTIFICATION SHALL BE SUBMITTED THAT THE EQUIPMENT HAS BEEN TESTED TO THE ORIGINAL MANUFACTURER'S SPECIFICATIONS AND IS IN GOOD WORKING CONDITION, AND THAT ALL APPLICABLE NEMA ENVIRONMENT STANDARDS ARE MET. WHEN THE CONTRACTOR SUPPLIES AND USES TEMPORARY EQUIPMENT, HE ASSUMES ALL MAINTENANCE RESPONSIBILITIES ASSOCIATED WITH THAT EQUIPMENT, AND RETAINS POSSESSION OF THE EQUIPMENT AT THE END OF ITS USE.

TYPICAL PAY ITEMS THAT MAY BE INCLUDED IN THE PLANS FOR USE IN TEMPORARY SIGNALS INCLUDE WOOD POLES, GUYING DEVICES, SPAN WIRE, AND CONDUIT RISERS, AND THESE ITEMS WILL BE SO NOTED. THERE WILL BE NO DIRECT PAYMENT FOR OTHER COSTS RELATED TO RELOCATING OR REPOSITIONING SIGNAL EQUIPMENT OR FOR TEMPORARY EQUIPMENT PROVIDED AT THE CONTRACTOR'S DISCRETION.

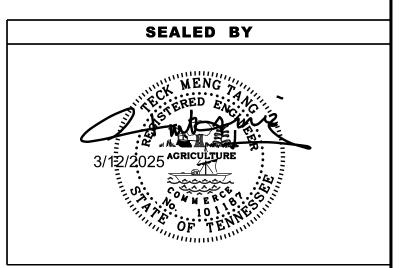


STATE OF TENNESSEE DEPARTMENT OF TRANSPORTATION

TRAFFIC PHASING NOTES, LEGEND AND TABULATION

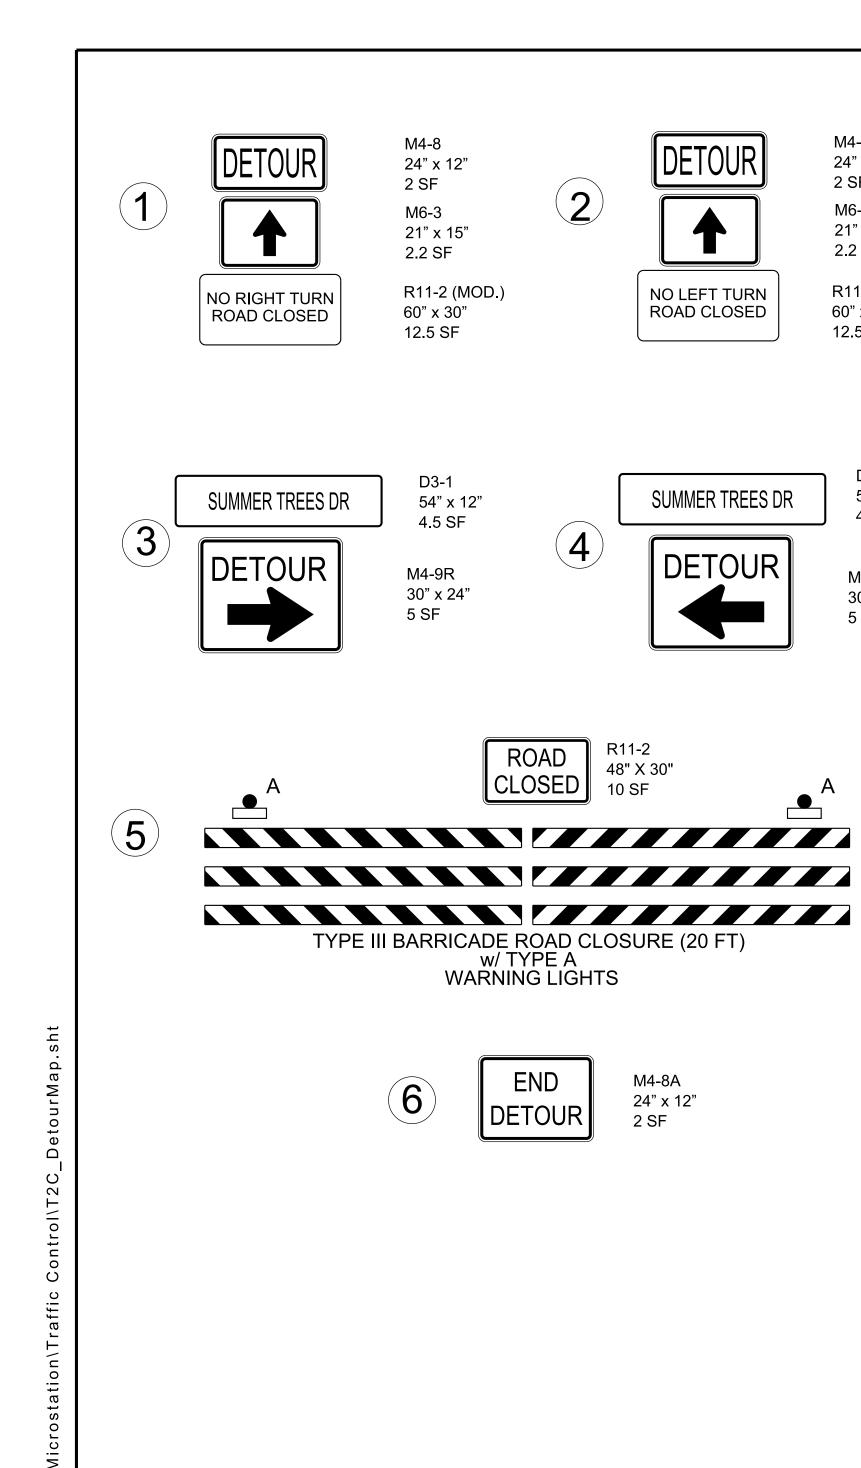

3/19/2025 10:27:37 AM P:\00_ALL_1990s PROJECTS\97007-SUMMER

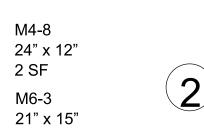

2.2 SF

60" x 30"

12.5 SF

R11-2 (MOD.)

54" x 12"

M4-9R 30" x 24" 5 SF



R11-2 48" X 30"

M4-8A 24" x 12"

CLOSED

NO LEFT TURN ROAD CLOSED

M4-8 24" x 12" 2 SF M6-3 21" x 15"

2.2 SF


R11-2 (MOD.) 60" x 30" 12.5 SF

TRAFFIC CONTROL LEGEND					
/MBOL	ITEM				
þ	SIGN (CONSTRUCTION)				
	TEMPORARY BARRICADE (TYPE III)				

TYPE	YEAR	PROJECT NO.	NO.	
PS&E	2025	NH-1(424)	T2C	

REV. 3-12-25: REVISED QUANTITY ON ITEM NO. 712-06

		TRAFFIC CONTROL QUANTITIES					
	D3-1 54" x 12"	ITEM NO.	DESCRIPTION	UNIT	QUANTITY		
SUMMER TREES DR	4.5 SF	712-05.01	WARNING LIGHTS (TYPE A)	E.A.	8		
DETOUR	M4-9L 30" x 24"	712-06	SIGNS (CONSTRUCTION)	S.F.	133		
	5 SF	712-07.03	TEMPORARY BARRICADE (TYPE III)	L.F.	80		

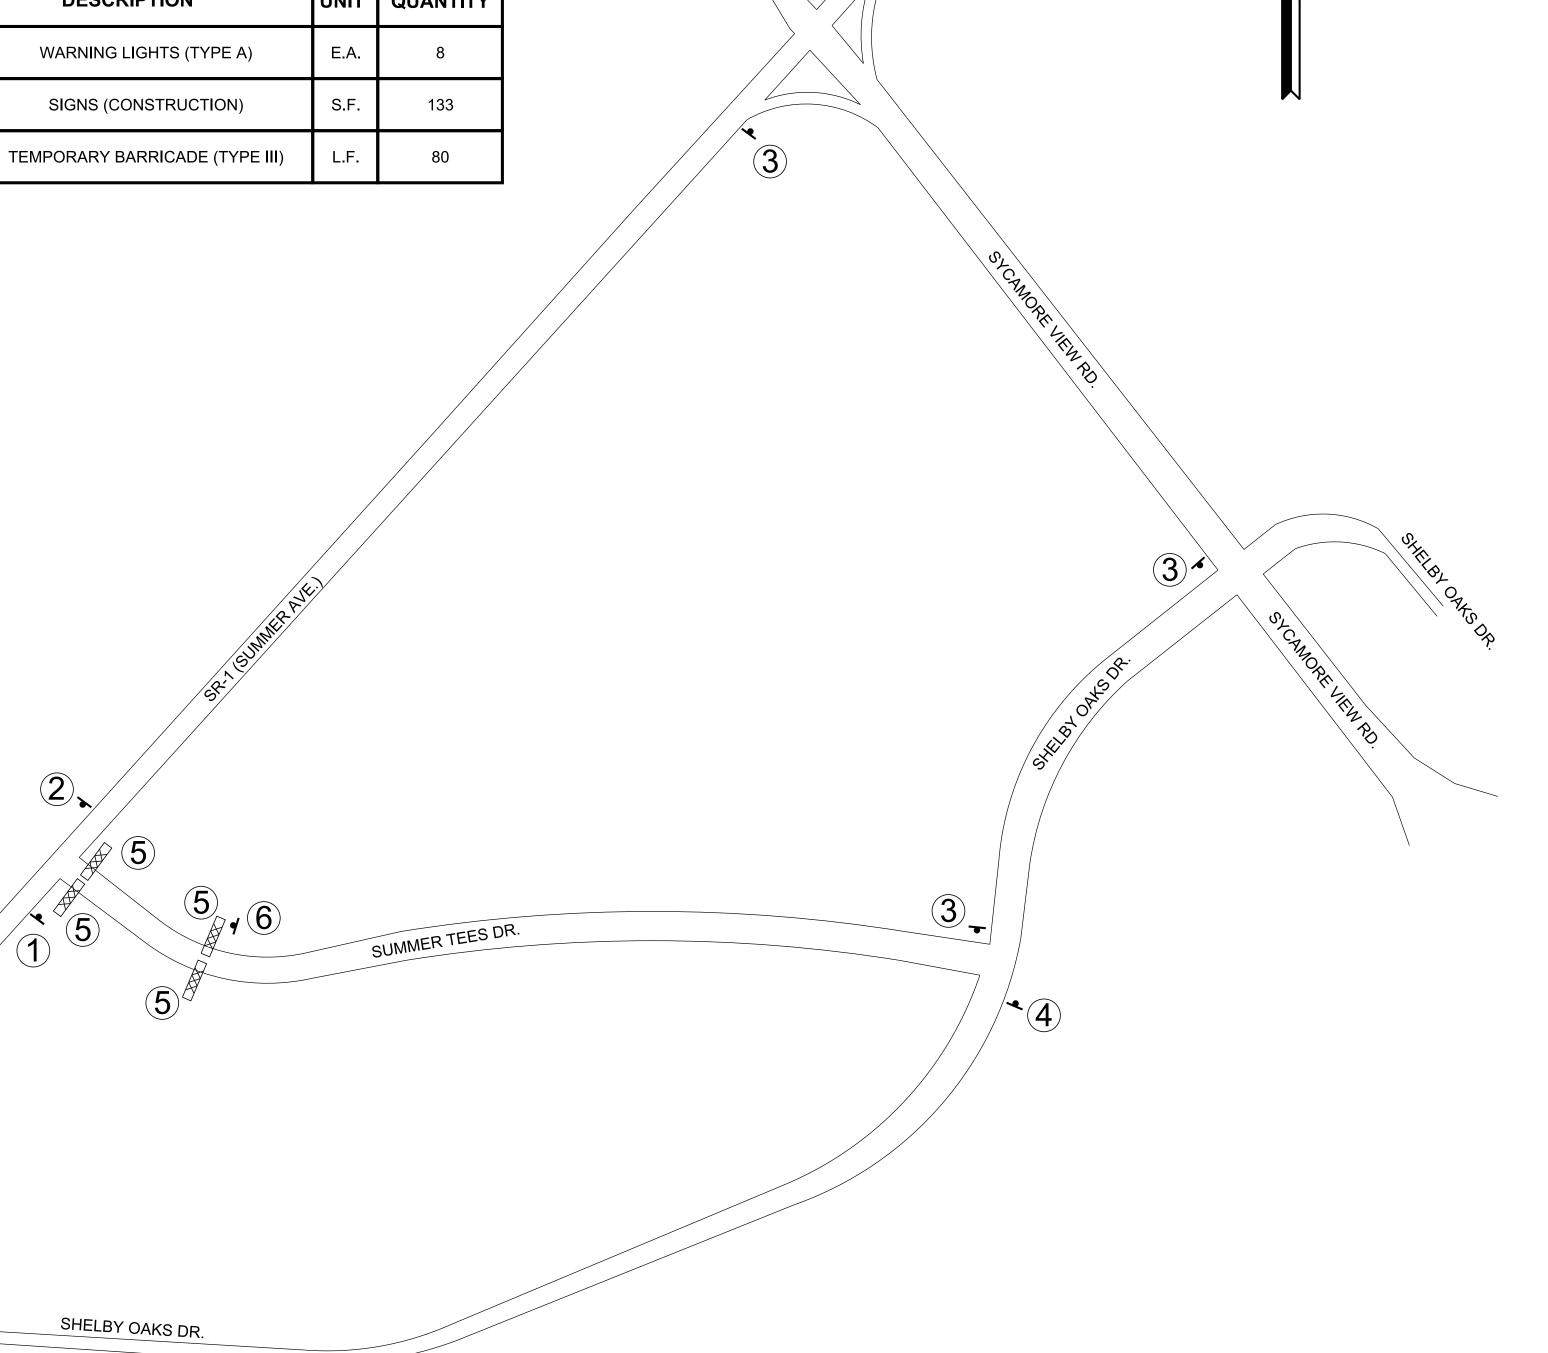



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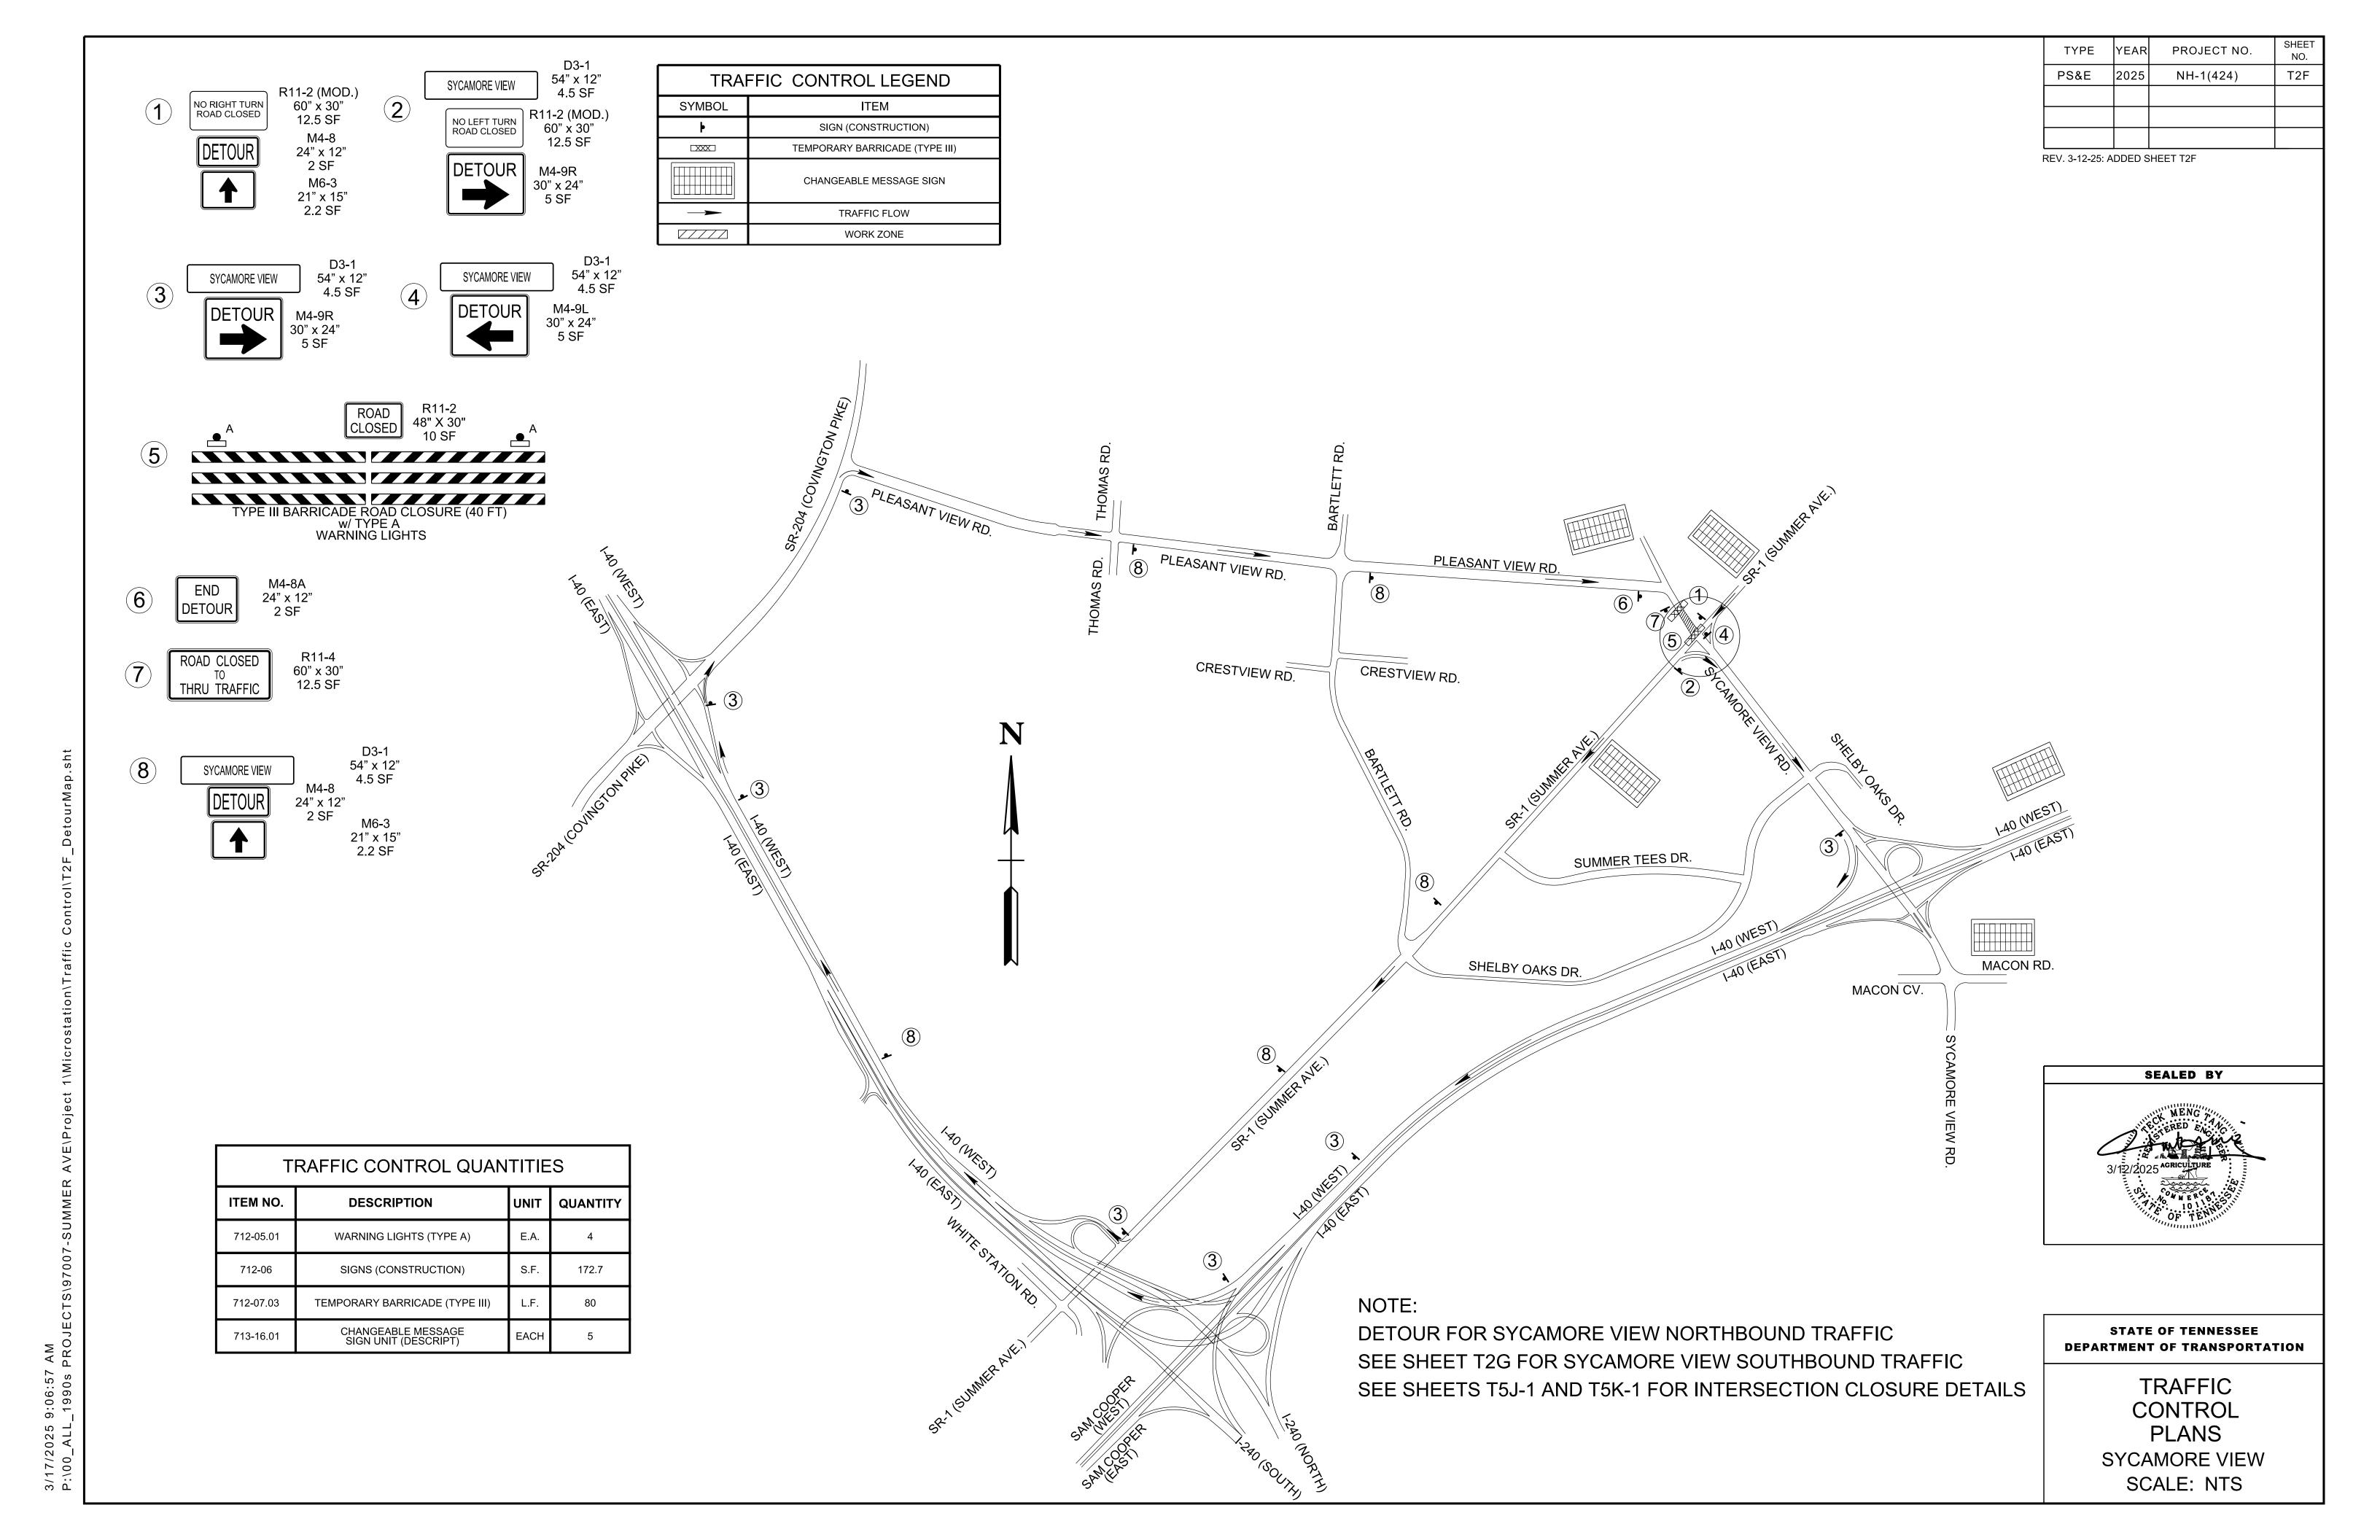
STATE OF TENNESSEE DEPARTMENT OF TRANSPORTATION


> TRAFFIC CONTROL


SUMMER TREES DR. CLOSURE SCALE: NTS



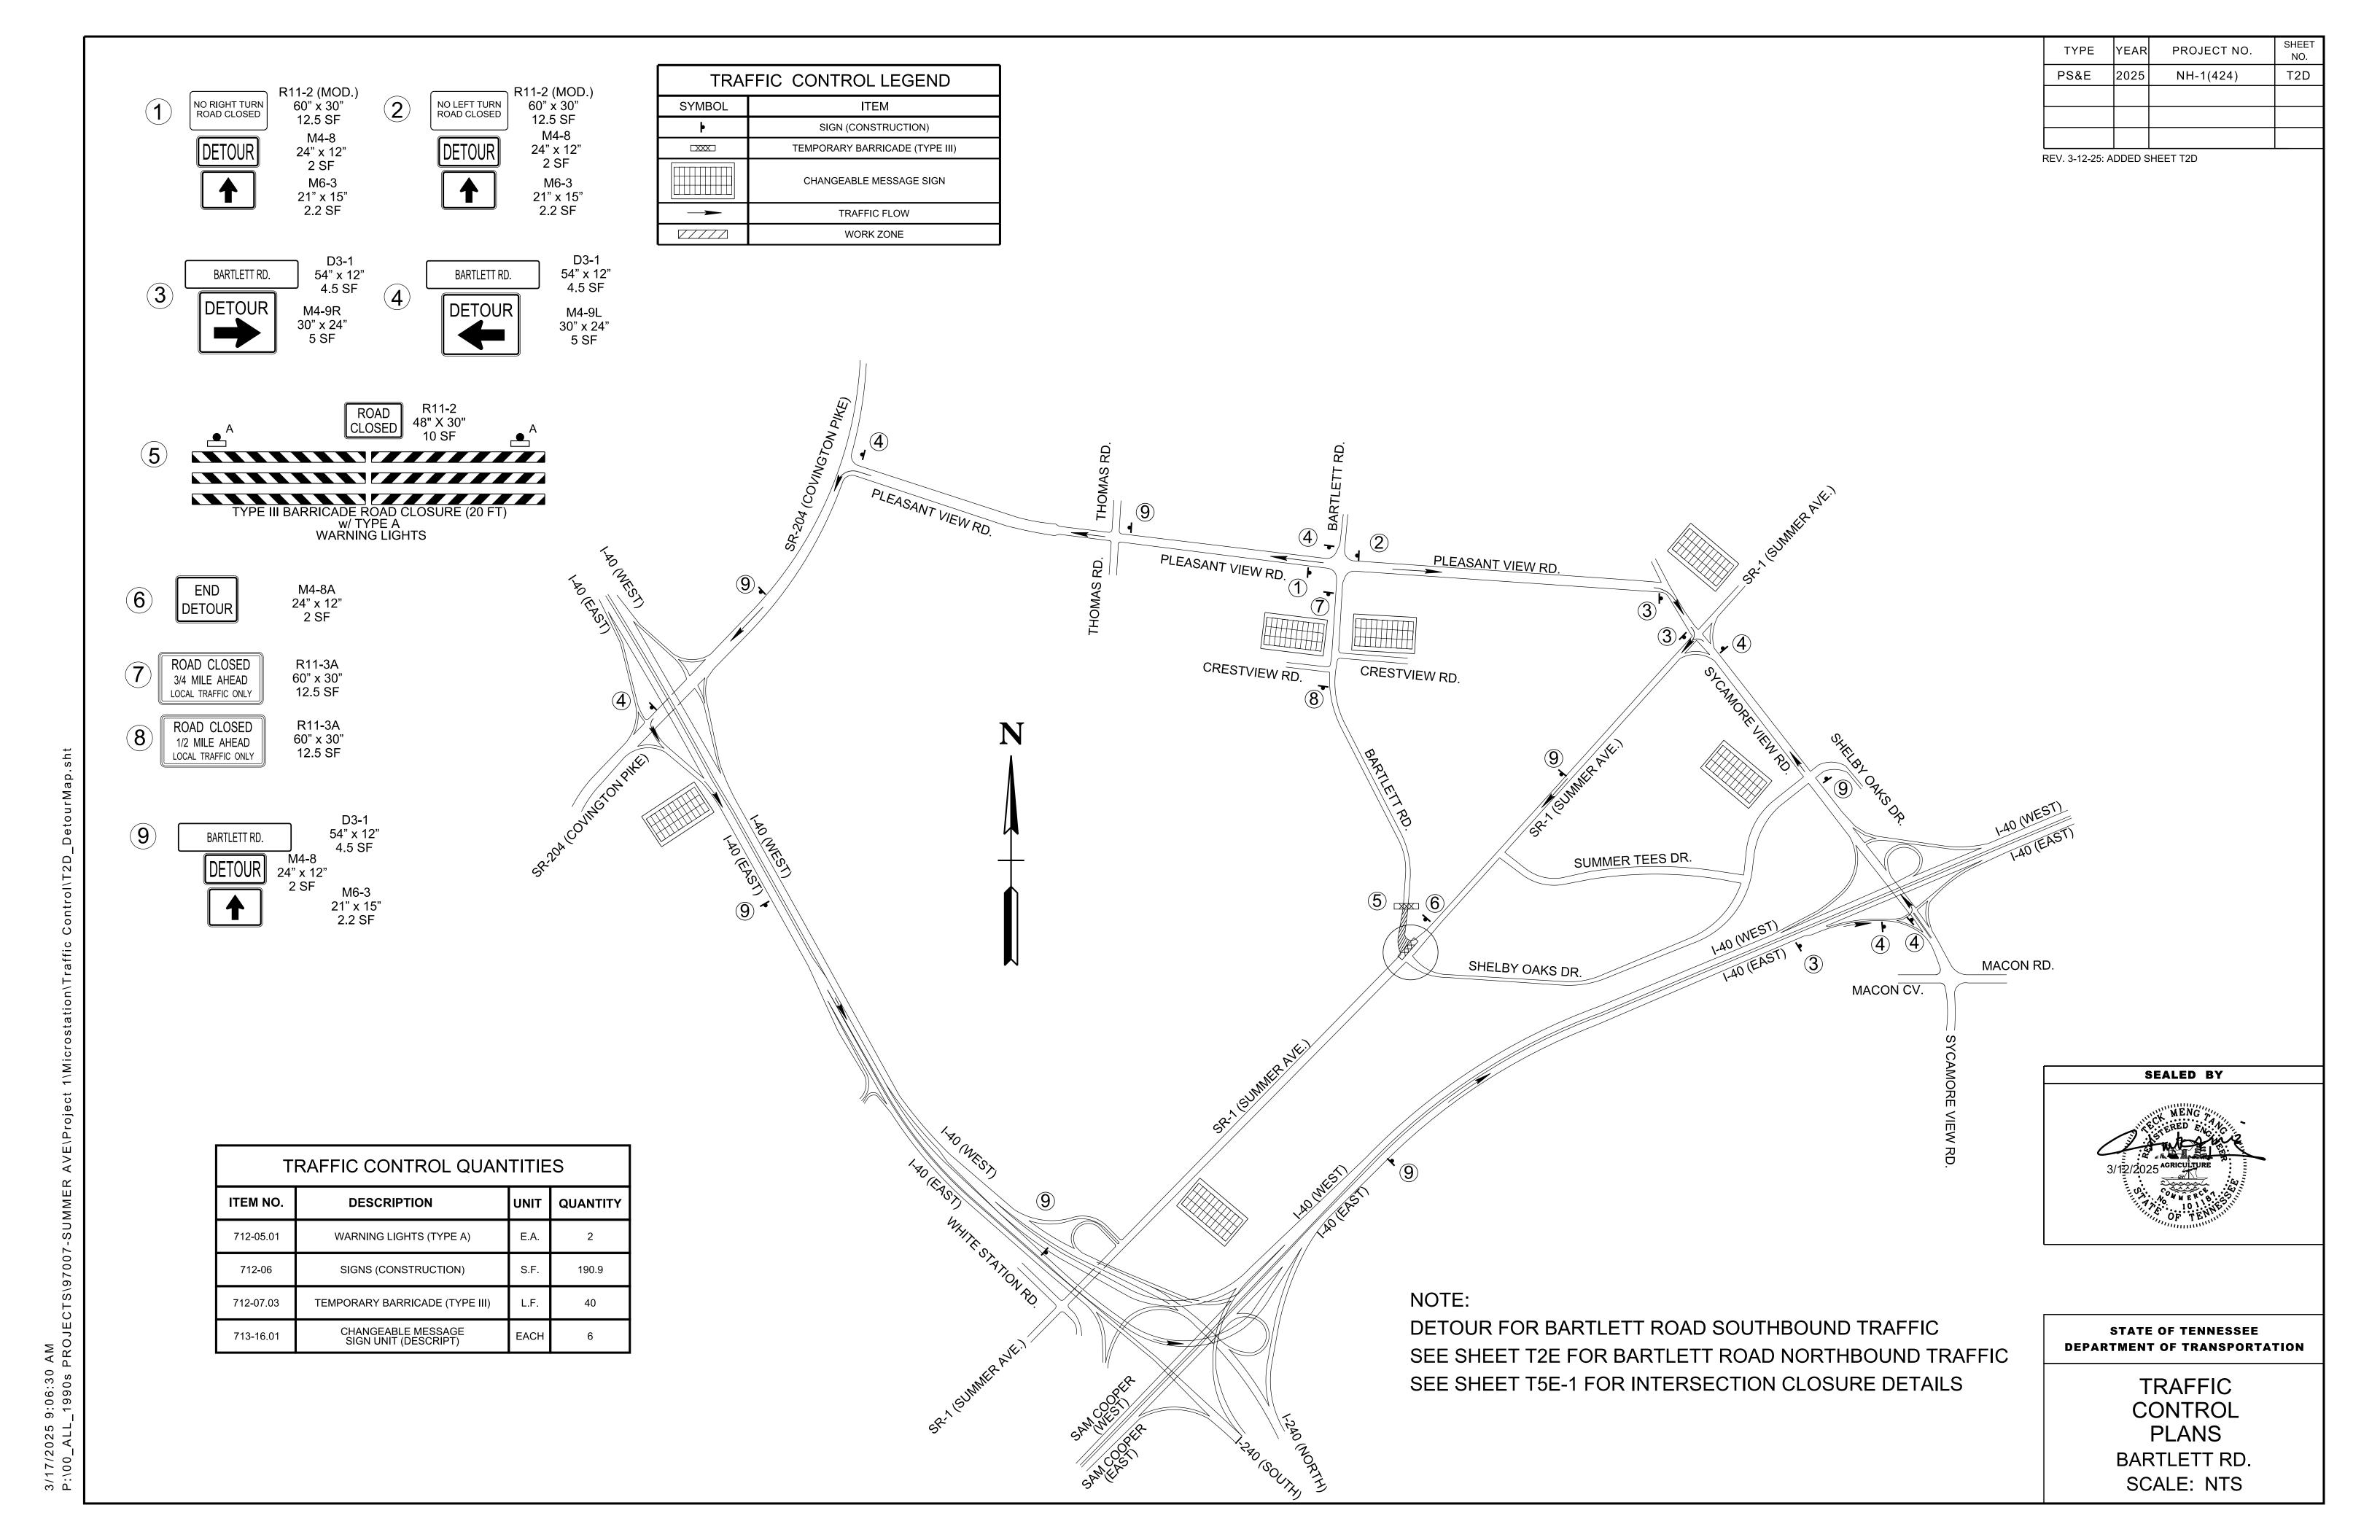

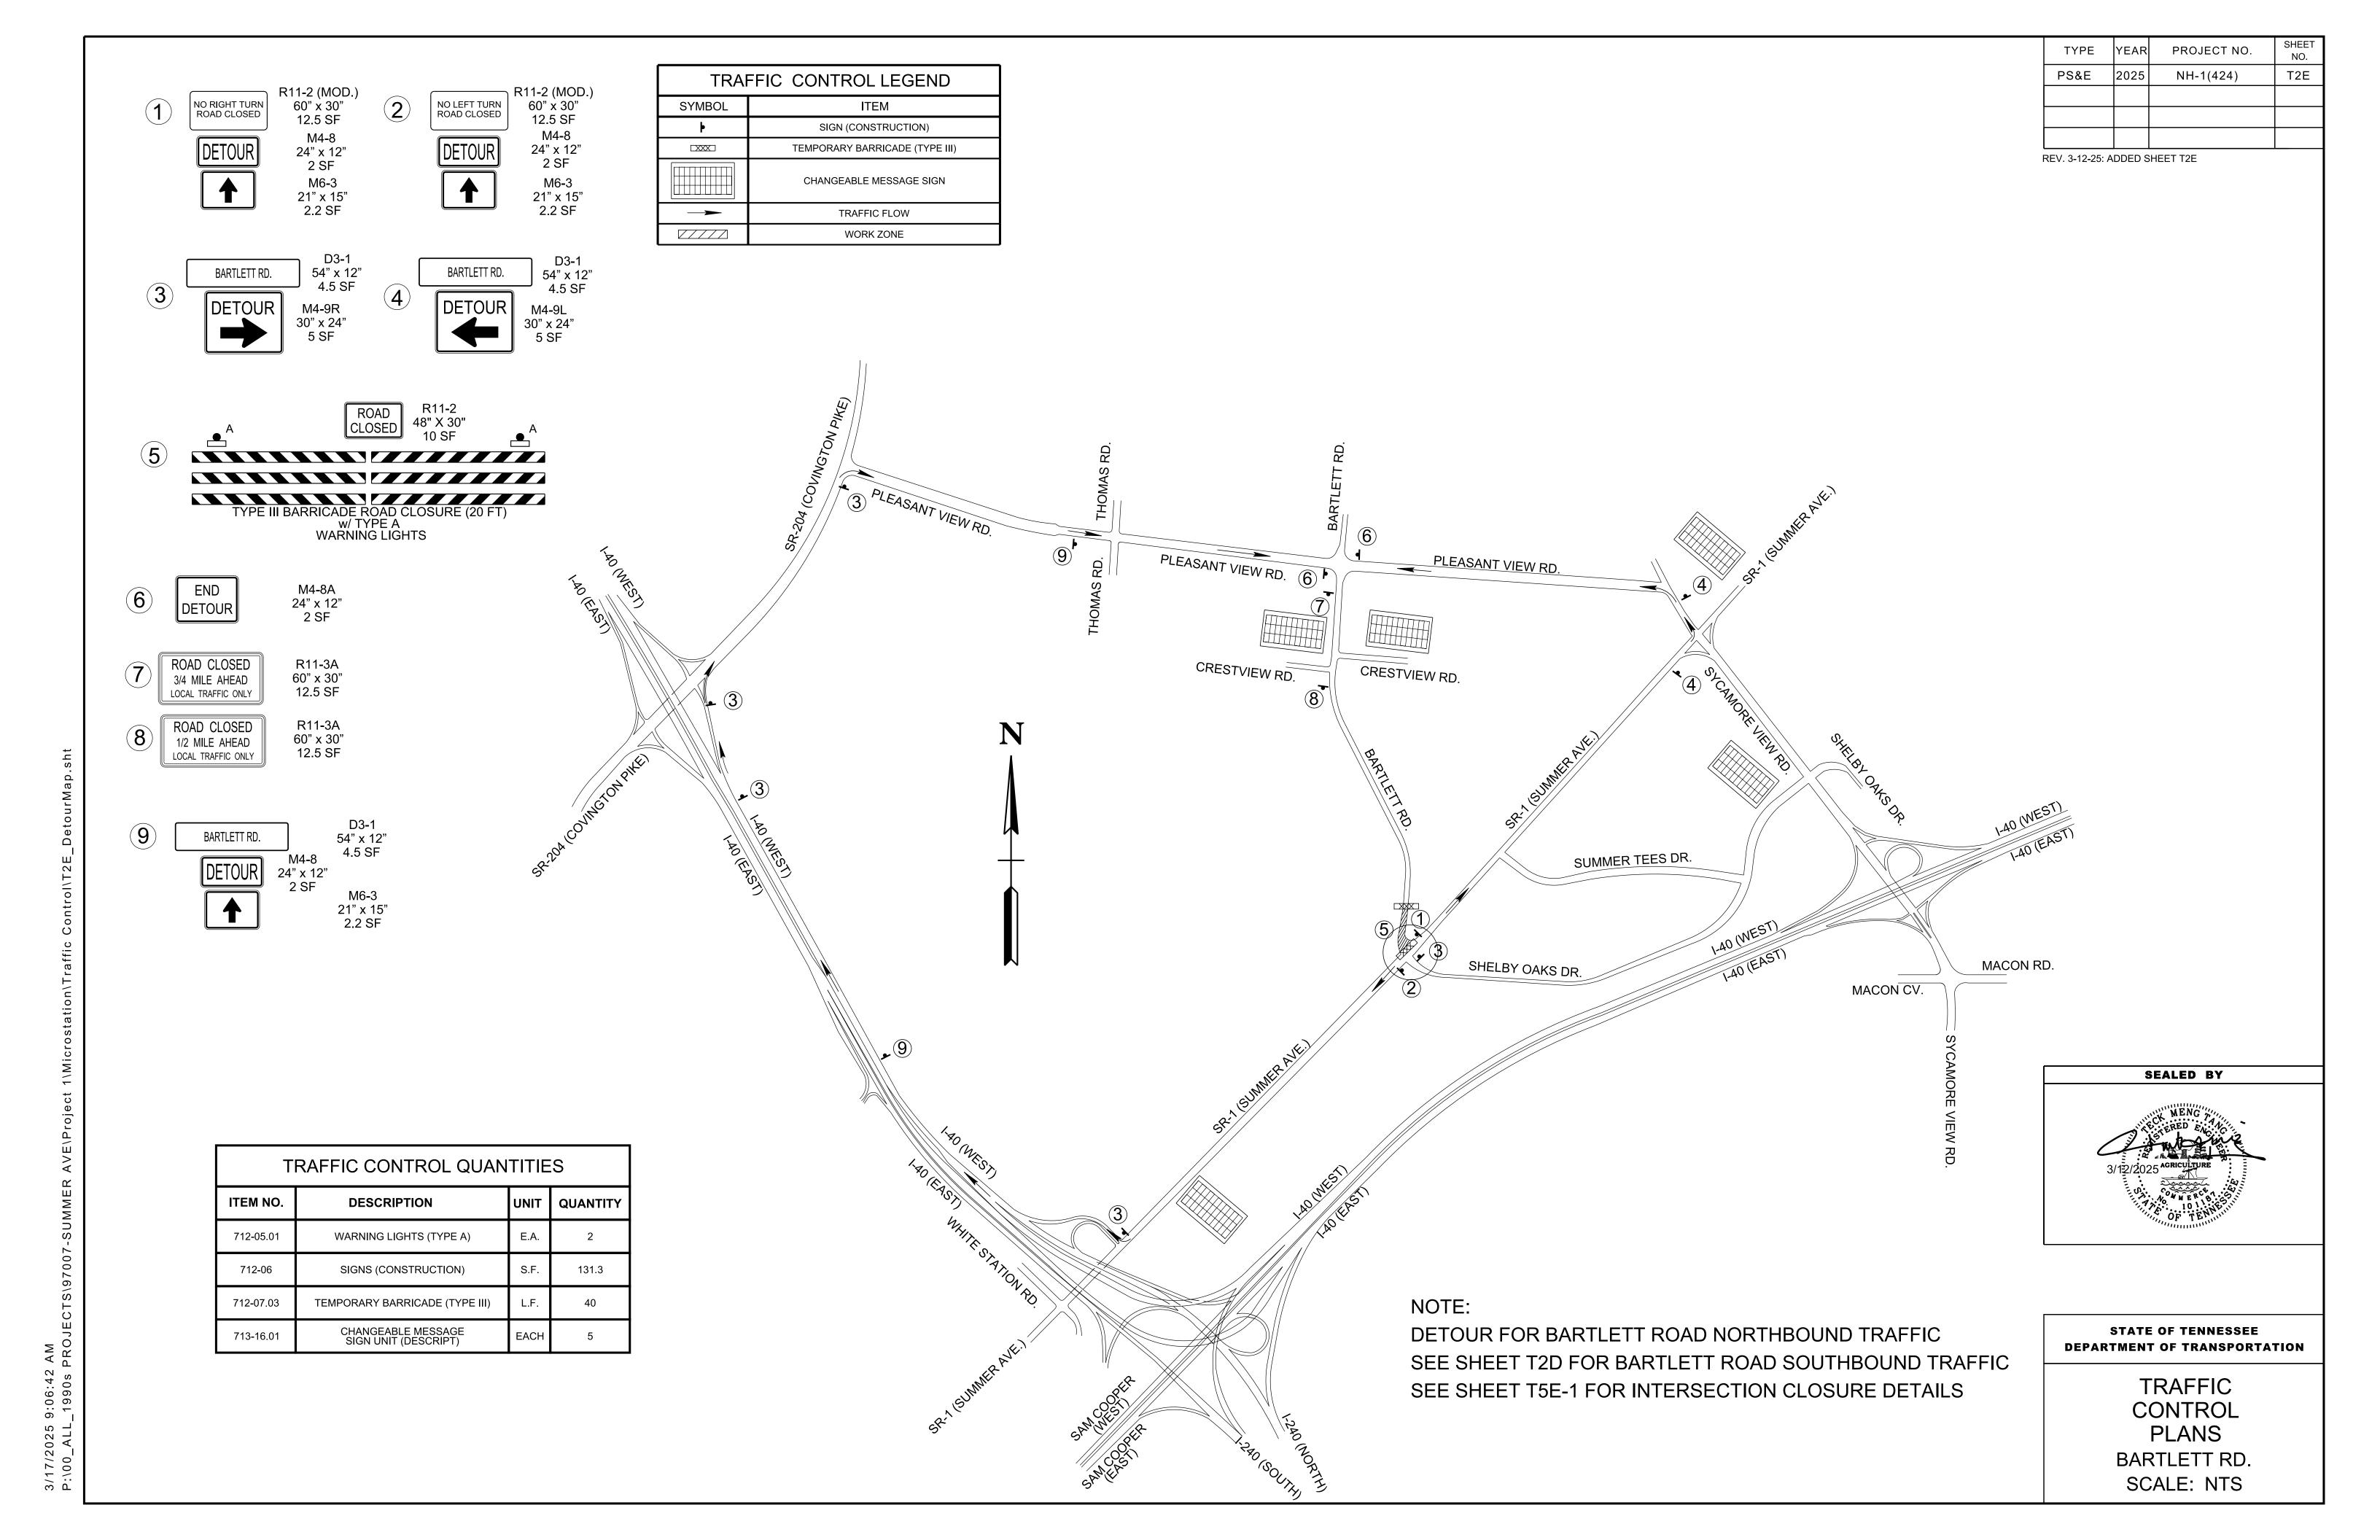

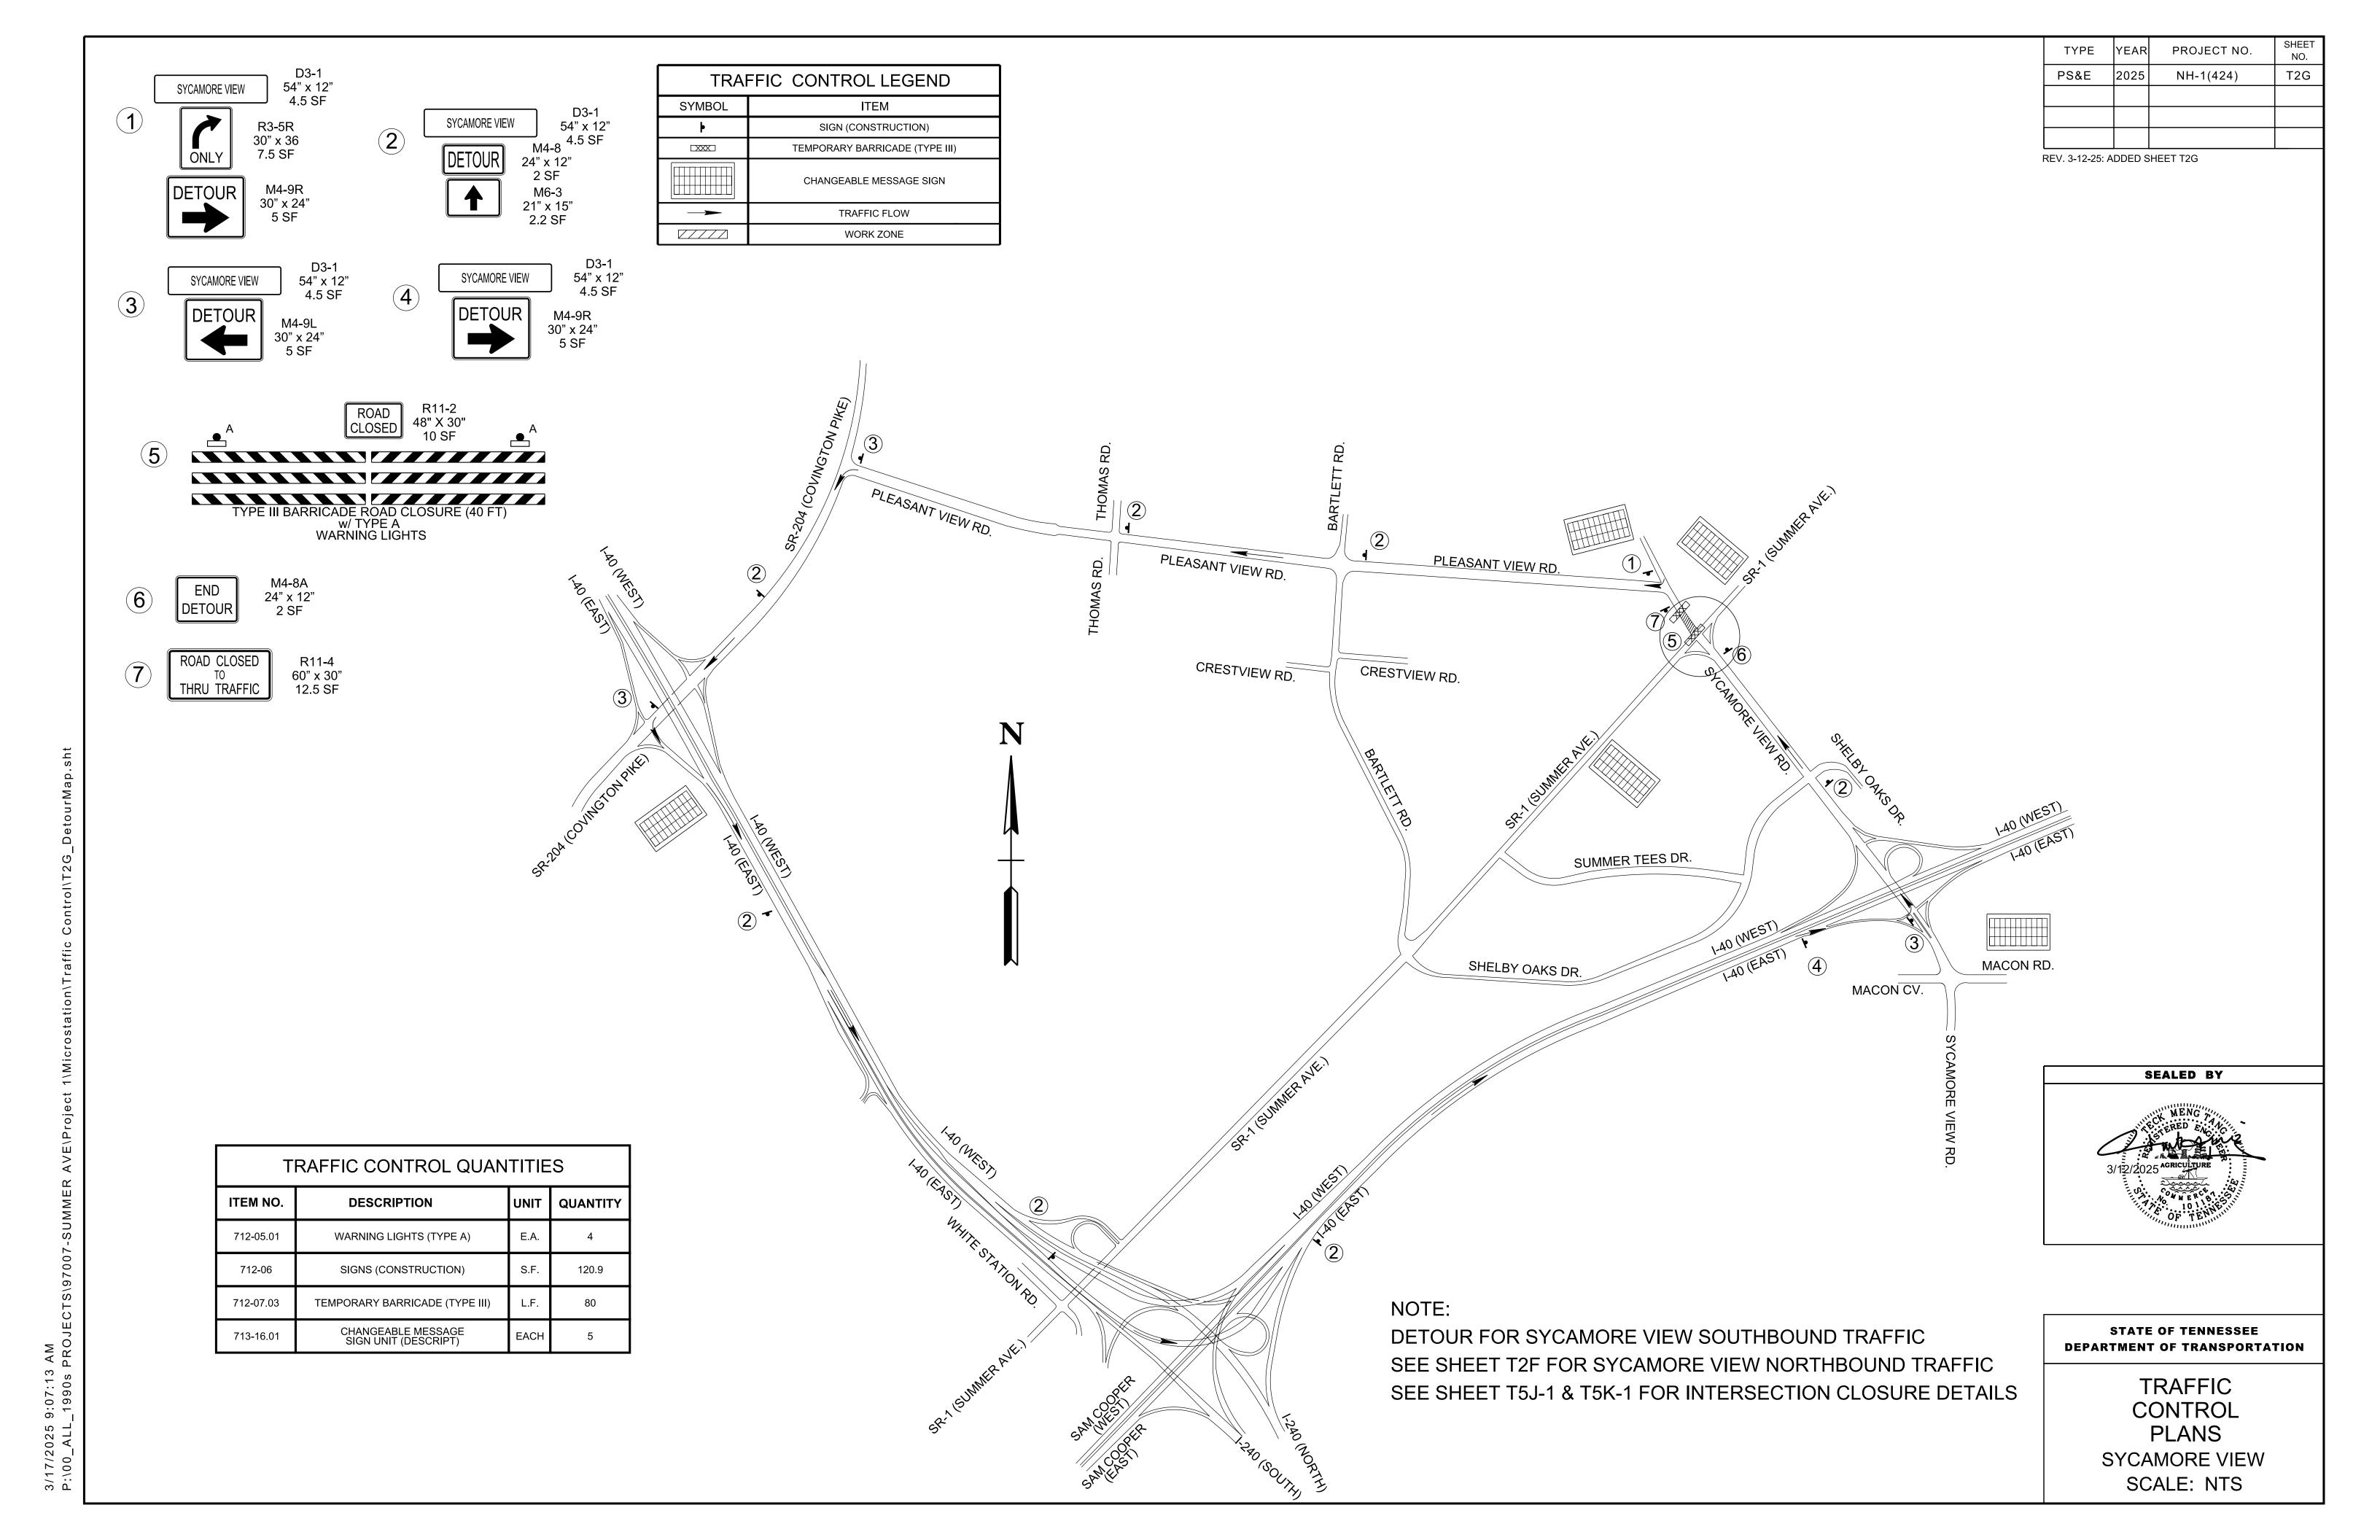


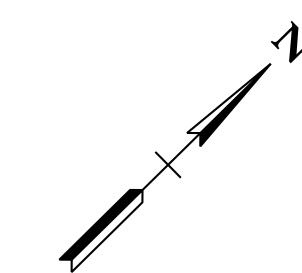

TYPE	YEAR	PROJECT NO.	SHEET NO.
PS&E	2025	NH-1(424)	T5D

REV. 3-12-25: ADDED MATCHLINE SEE SHT. T5E-1.

7

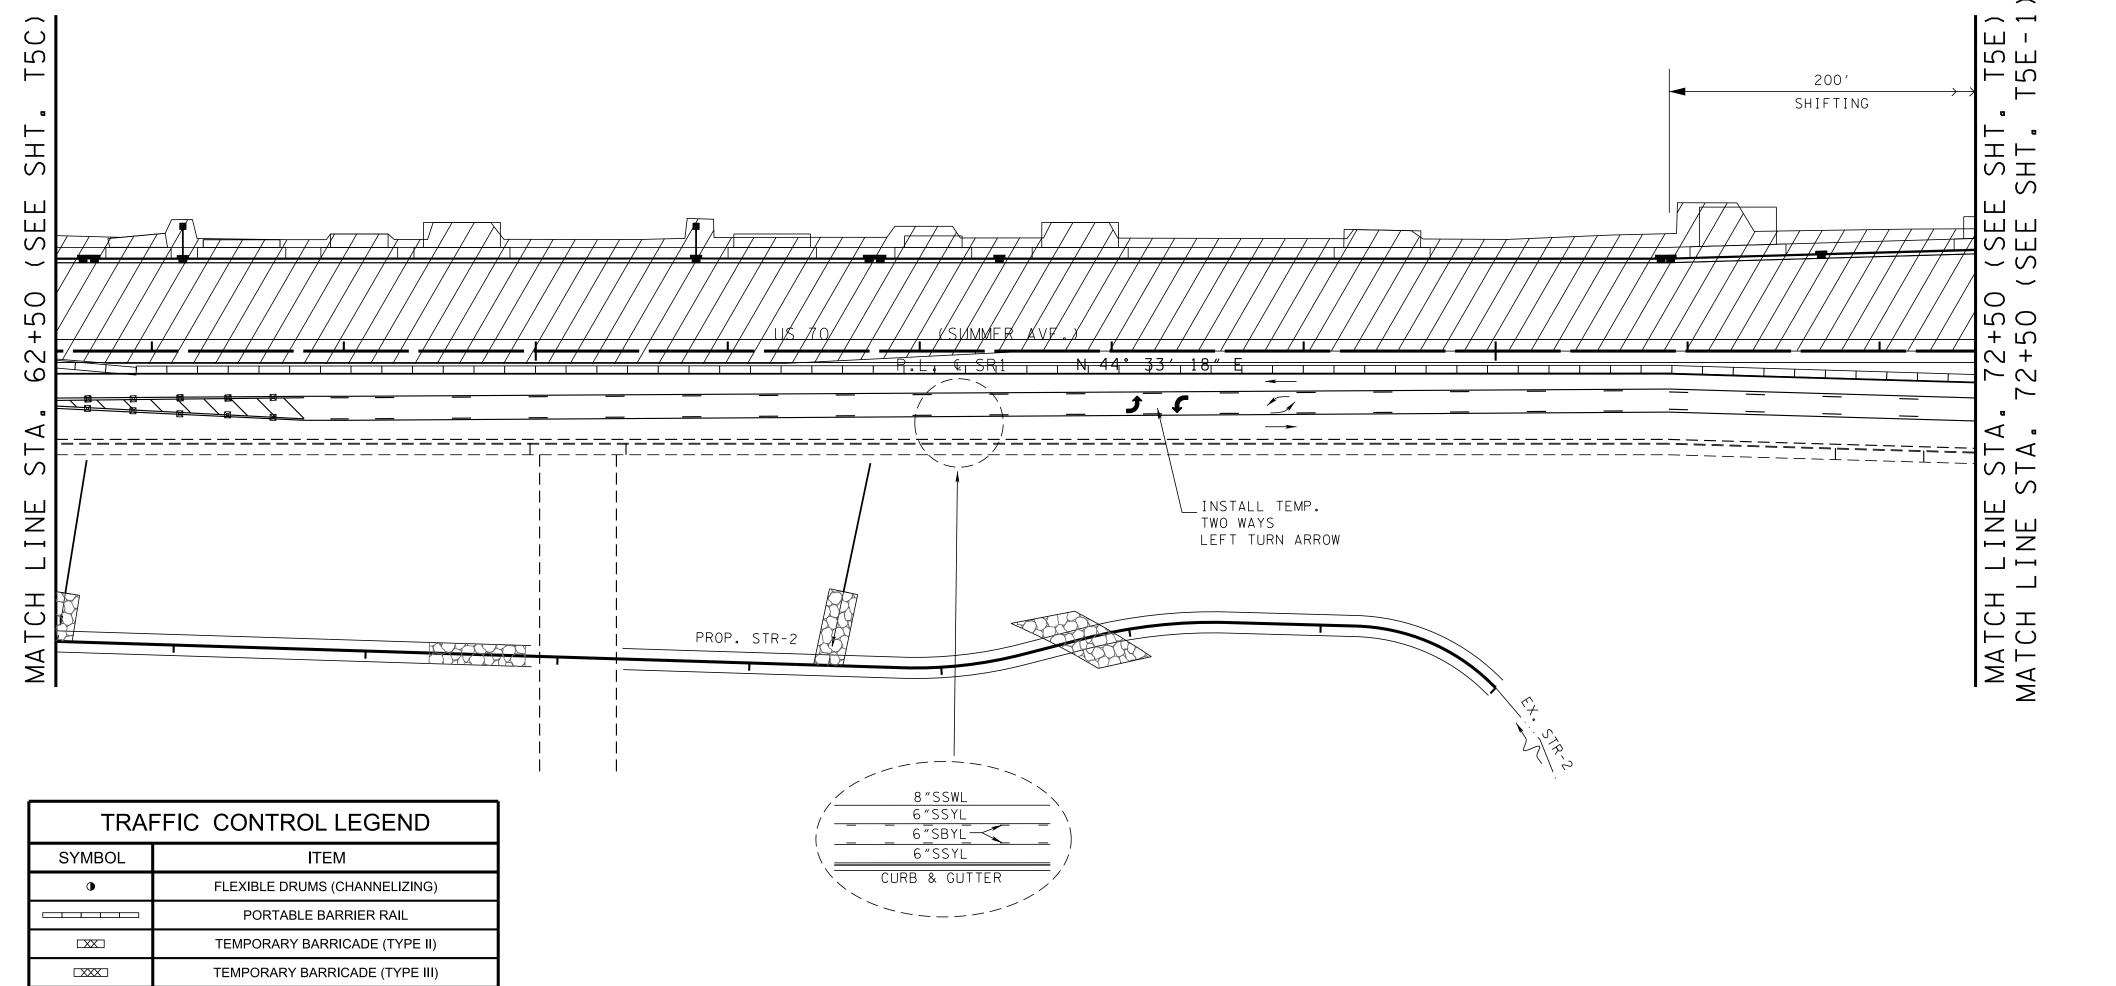


NOTE: FLEXIBLE DRUMS SHALL BE SPACED 20' ON SHIFTING TAPERS & 50' ON TANGENT UNLESS SHOWN PER PLANS.

DELINEATOR SHALL BE SPACED 40' ON SHIFTING TAPERS & 80' ON TANGENT UNLESS SHOWN PER PLANS.

CONTRACTOR SHALL MAINTAIN ACESS TO PRIVATE DRIVES AT ALL TIMES DURING CONSTRUCTIONS.

65

MAINTAIN TRAFFIC ON THE SOUTH SIDE (EB) WITH THREE 11-FT LANES AND CONSTRUCT THE NEW ROADWAY ON THE NORTH SIDE (WB).

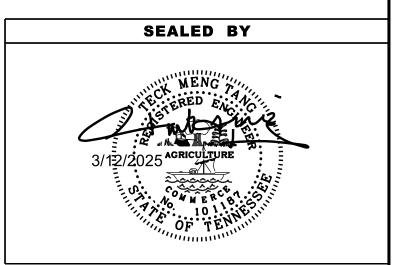


COORDINATES ARE NAD 83(1995), ARE DATUM ADJUSTED BY THE FACTOR OF 1.00006 AND TIED TO THE TGRN. ALL ELEVATIONS ARE REFERENCED TO THE NAVD 1988.

STATE OF TENNESSEE DEPARTMENT OF TRANSPORTATION


TRAFFIC CONTROL PLANS

STA. 62+50 TO STA. 72+50 SCALE: 1"=50'

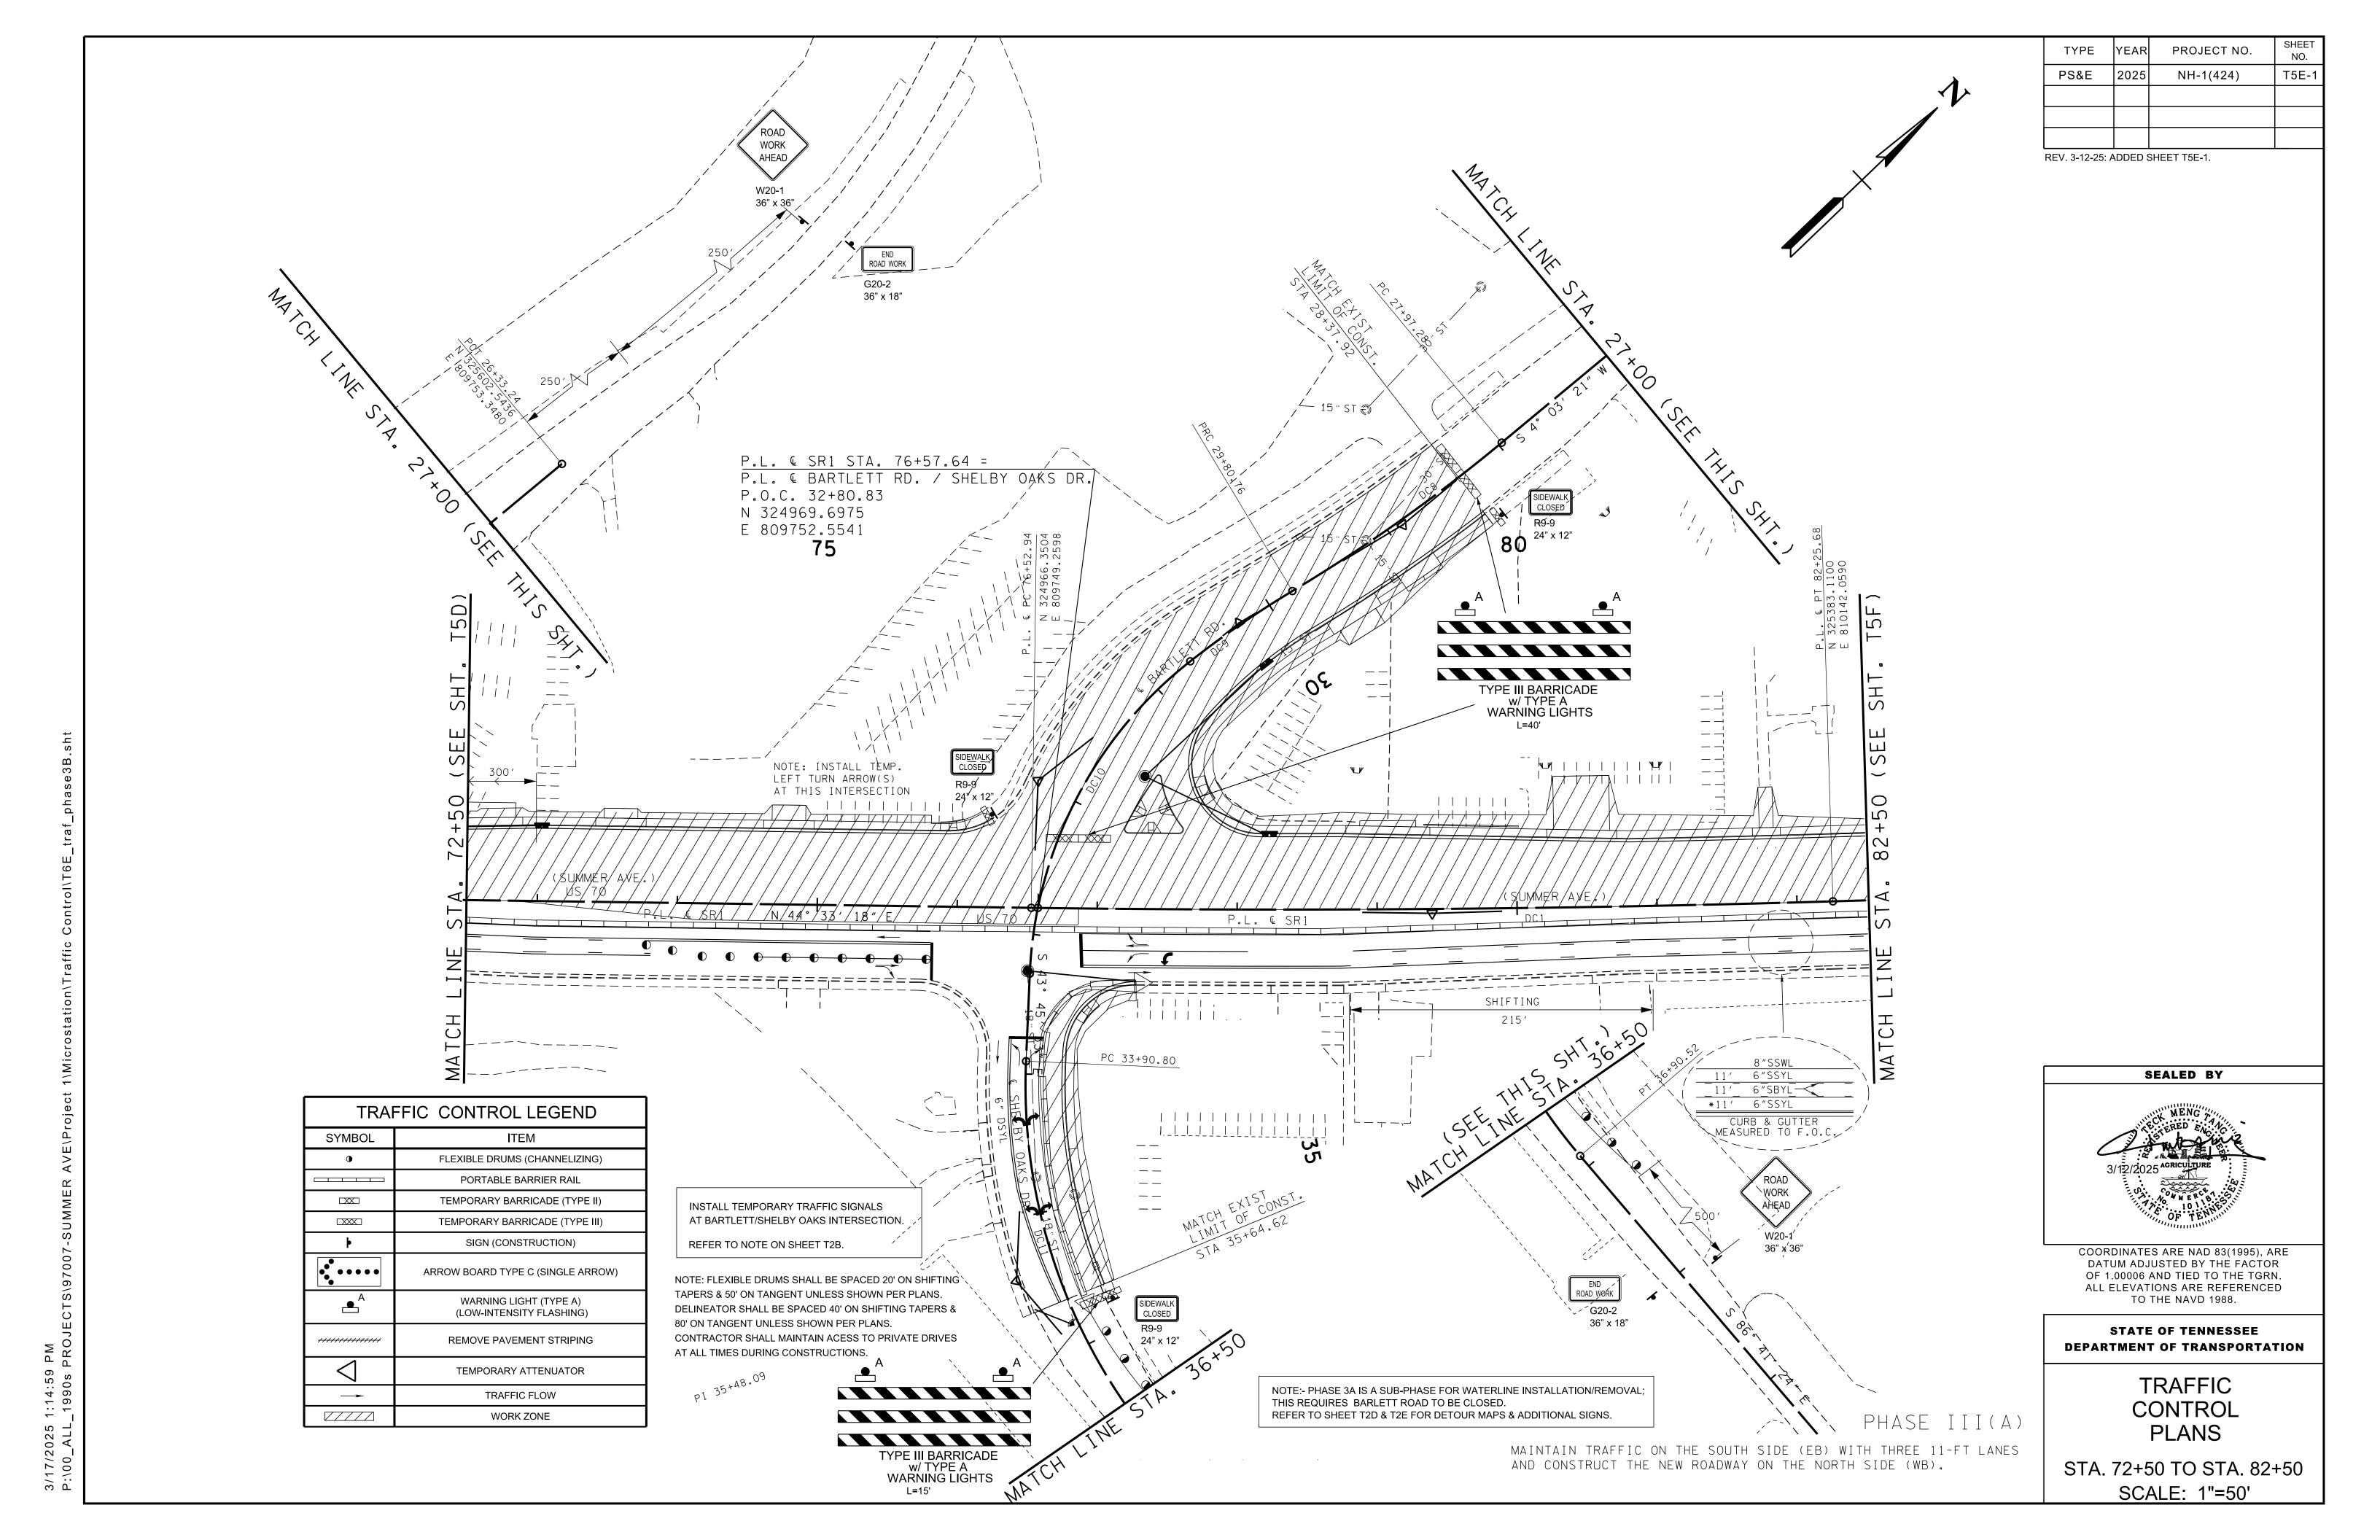

TYPE	YEAR	PROJECT NO.	SHEET NO.
PS&E	2025	NH-1(424)	T5F
			·

REV. 3-12-25: ADDED MATCHLINE SEE SHT. T5E-1.

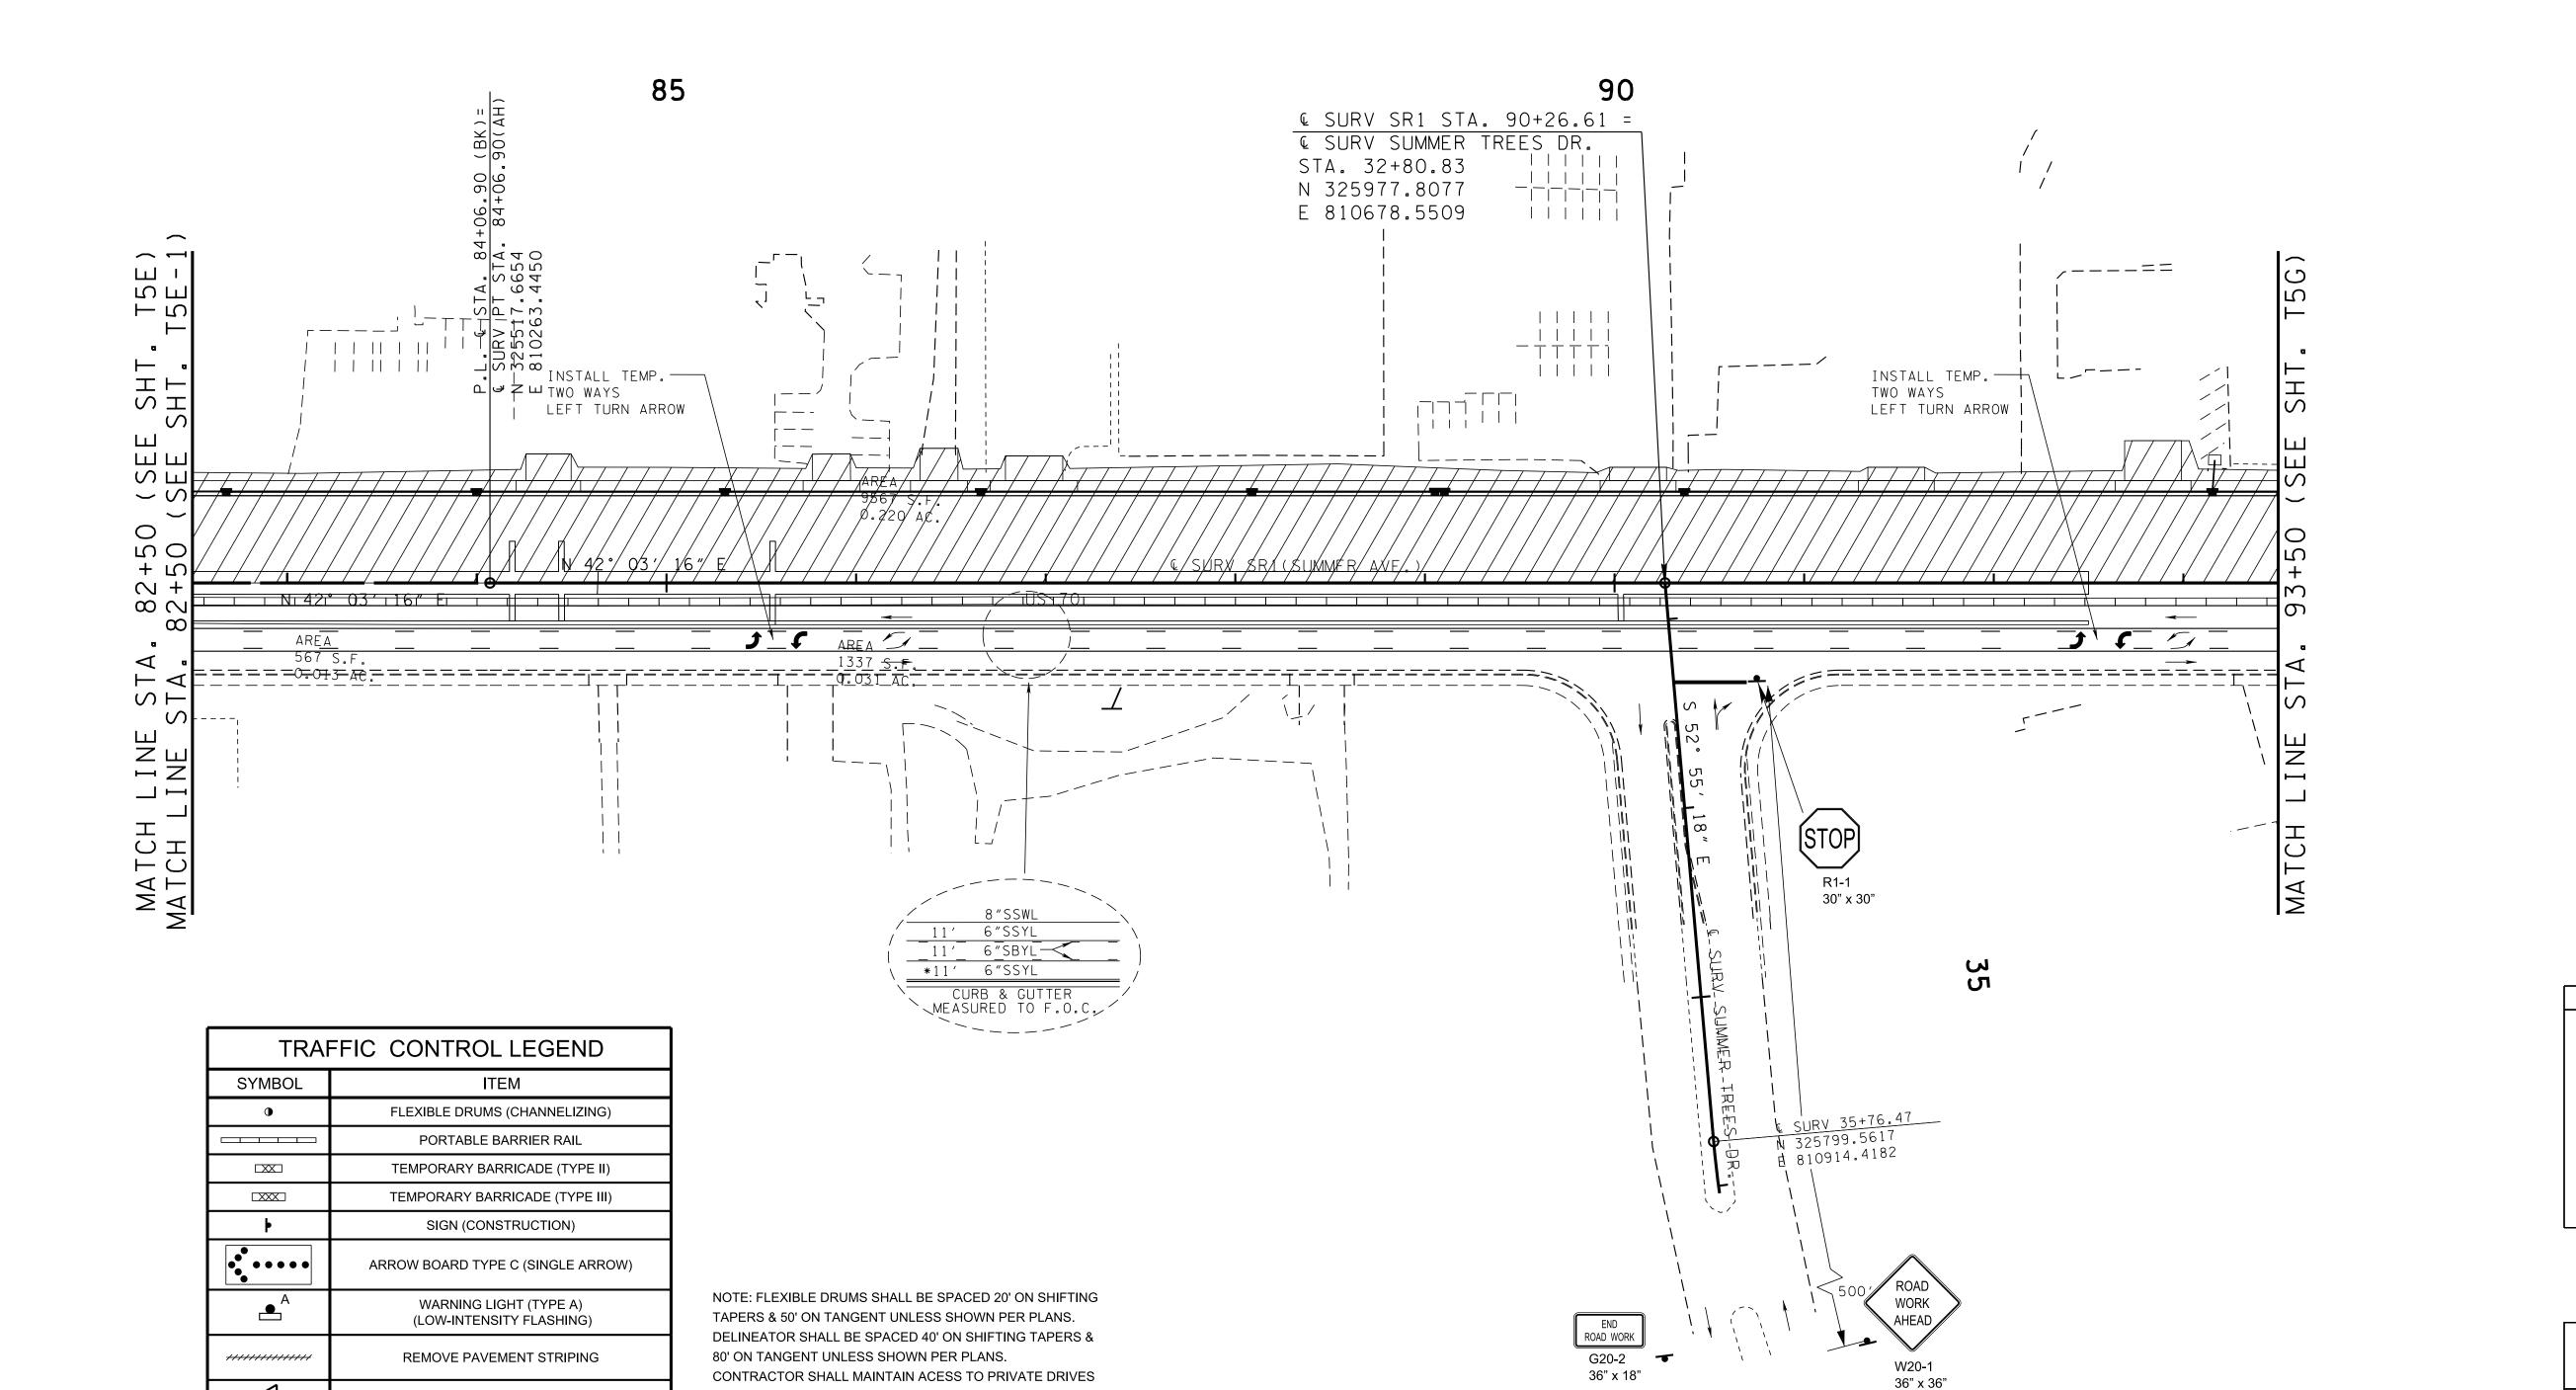

AT ALL TIMES DURING CONSTRUCTIONS.

TEMPORARY ATTENUATOR

TRAFFIC FLOW

WORK ZONE

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DEPARTMENT OF TRANSPORTATION

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TO THE NAVD 1988.

STATE OF TENNESSEE


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TRAFFIC CONTROL PLANS

STA. 82+50 TO STA. 93+50 SCALE: 1"=50'

PHASE III

MAINTAIN TRAFFIC ON THE SOUTH SIDE (EB) WITH THREE 11-FT LANES AND CONSTRUCT THE NEW ROADWAY ON THE NORTH SIDE (WB).

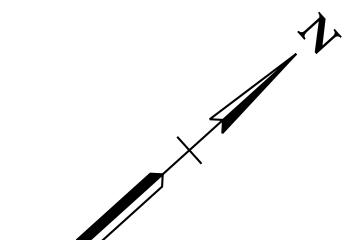

TYPE	YEAR	PROJECT NO.	SHEET NO.
PS&E	2025	NH-1(424)	T5H

REV. 3-12-25: ADDED MATCHLINE SEE SHT. T5J-1.

105	110	(BK) = (AH)
INSTALL TWO WAYS LEFT TURN WAYS VILVE SURV SURV SURV SURV SURV SURV SURV SURV		MATCH LINE STA. 114+50 (SEE SHT. T5J-1)
	8 "SSWL 11' 6 "SSYL 11' 6 "SBYL *11' 6 "SSYL	

TRAFFIC CONTROL LEGEND			
SYMBOL	ITEM		
•	FLEXIBLE DRUMS (CHANNELIZING)		
	PORTABLE BARRIER RAIL		
	TEMPORARY BARRICADE (TYPE II)		
	TEMPORARY BARRICADE (TYPE III)		
þ	SIGN (CONSTRUCTION)		
•••••	ARROW BOARD TYPE C (SINGLE ARROW)		
_ ^A	WARNING LIGHT (TYPE A) (LOW-INTENSITY FLASHING)		
/////////////////////////////////////	REMOVE PAVEMENT STRIPING		
	TEMPORARY ATTENUATOR		
→	TRAFFIC FLOW		
WORK ZONE			

NOTE: FLEXIBLE DRUMS SHALL BE SPACED 20' ON SHIFTING TAPERS & 50' ON TANGENT UNLESS SHOWN PER PLANS. DELINEATOR SHALL BE SPACED 40' ON SHIFTING TAPERS & 80' ON TANGENT UNLESS SHOWN PER PLANS. CONTRACTOR SHALL MAINTAIN ACESS TO PRIVATE DRIVES AT ALL TIMES DURING CONSTRUCTIONS.

PHASE III

TRAFFIC CONTROL PLANS

> STA. 103+50 TO STA. 114+50 SCALE: 1"=50'

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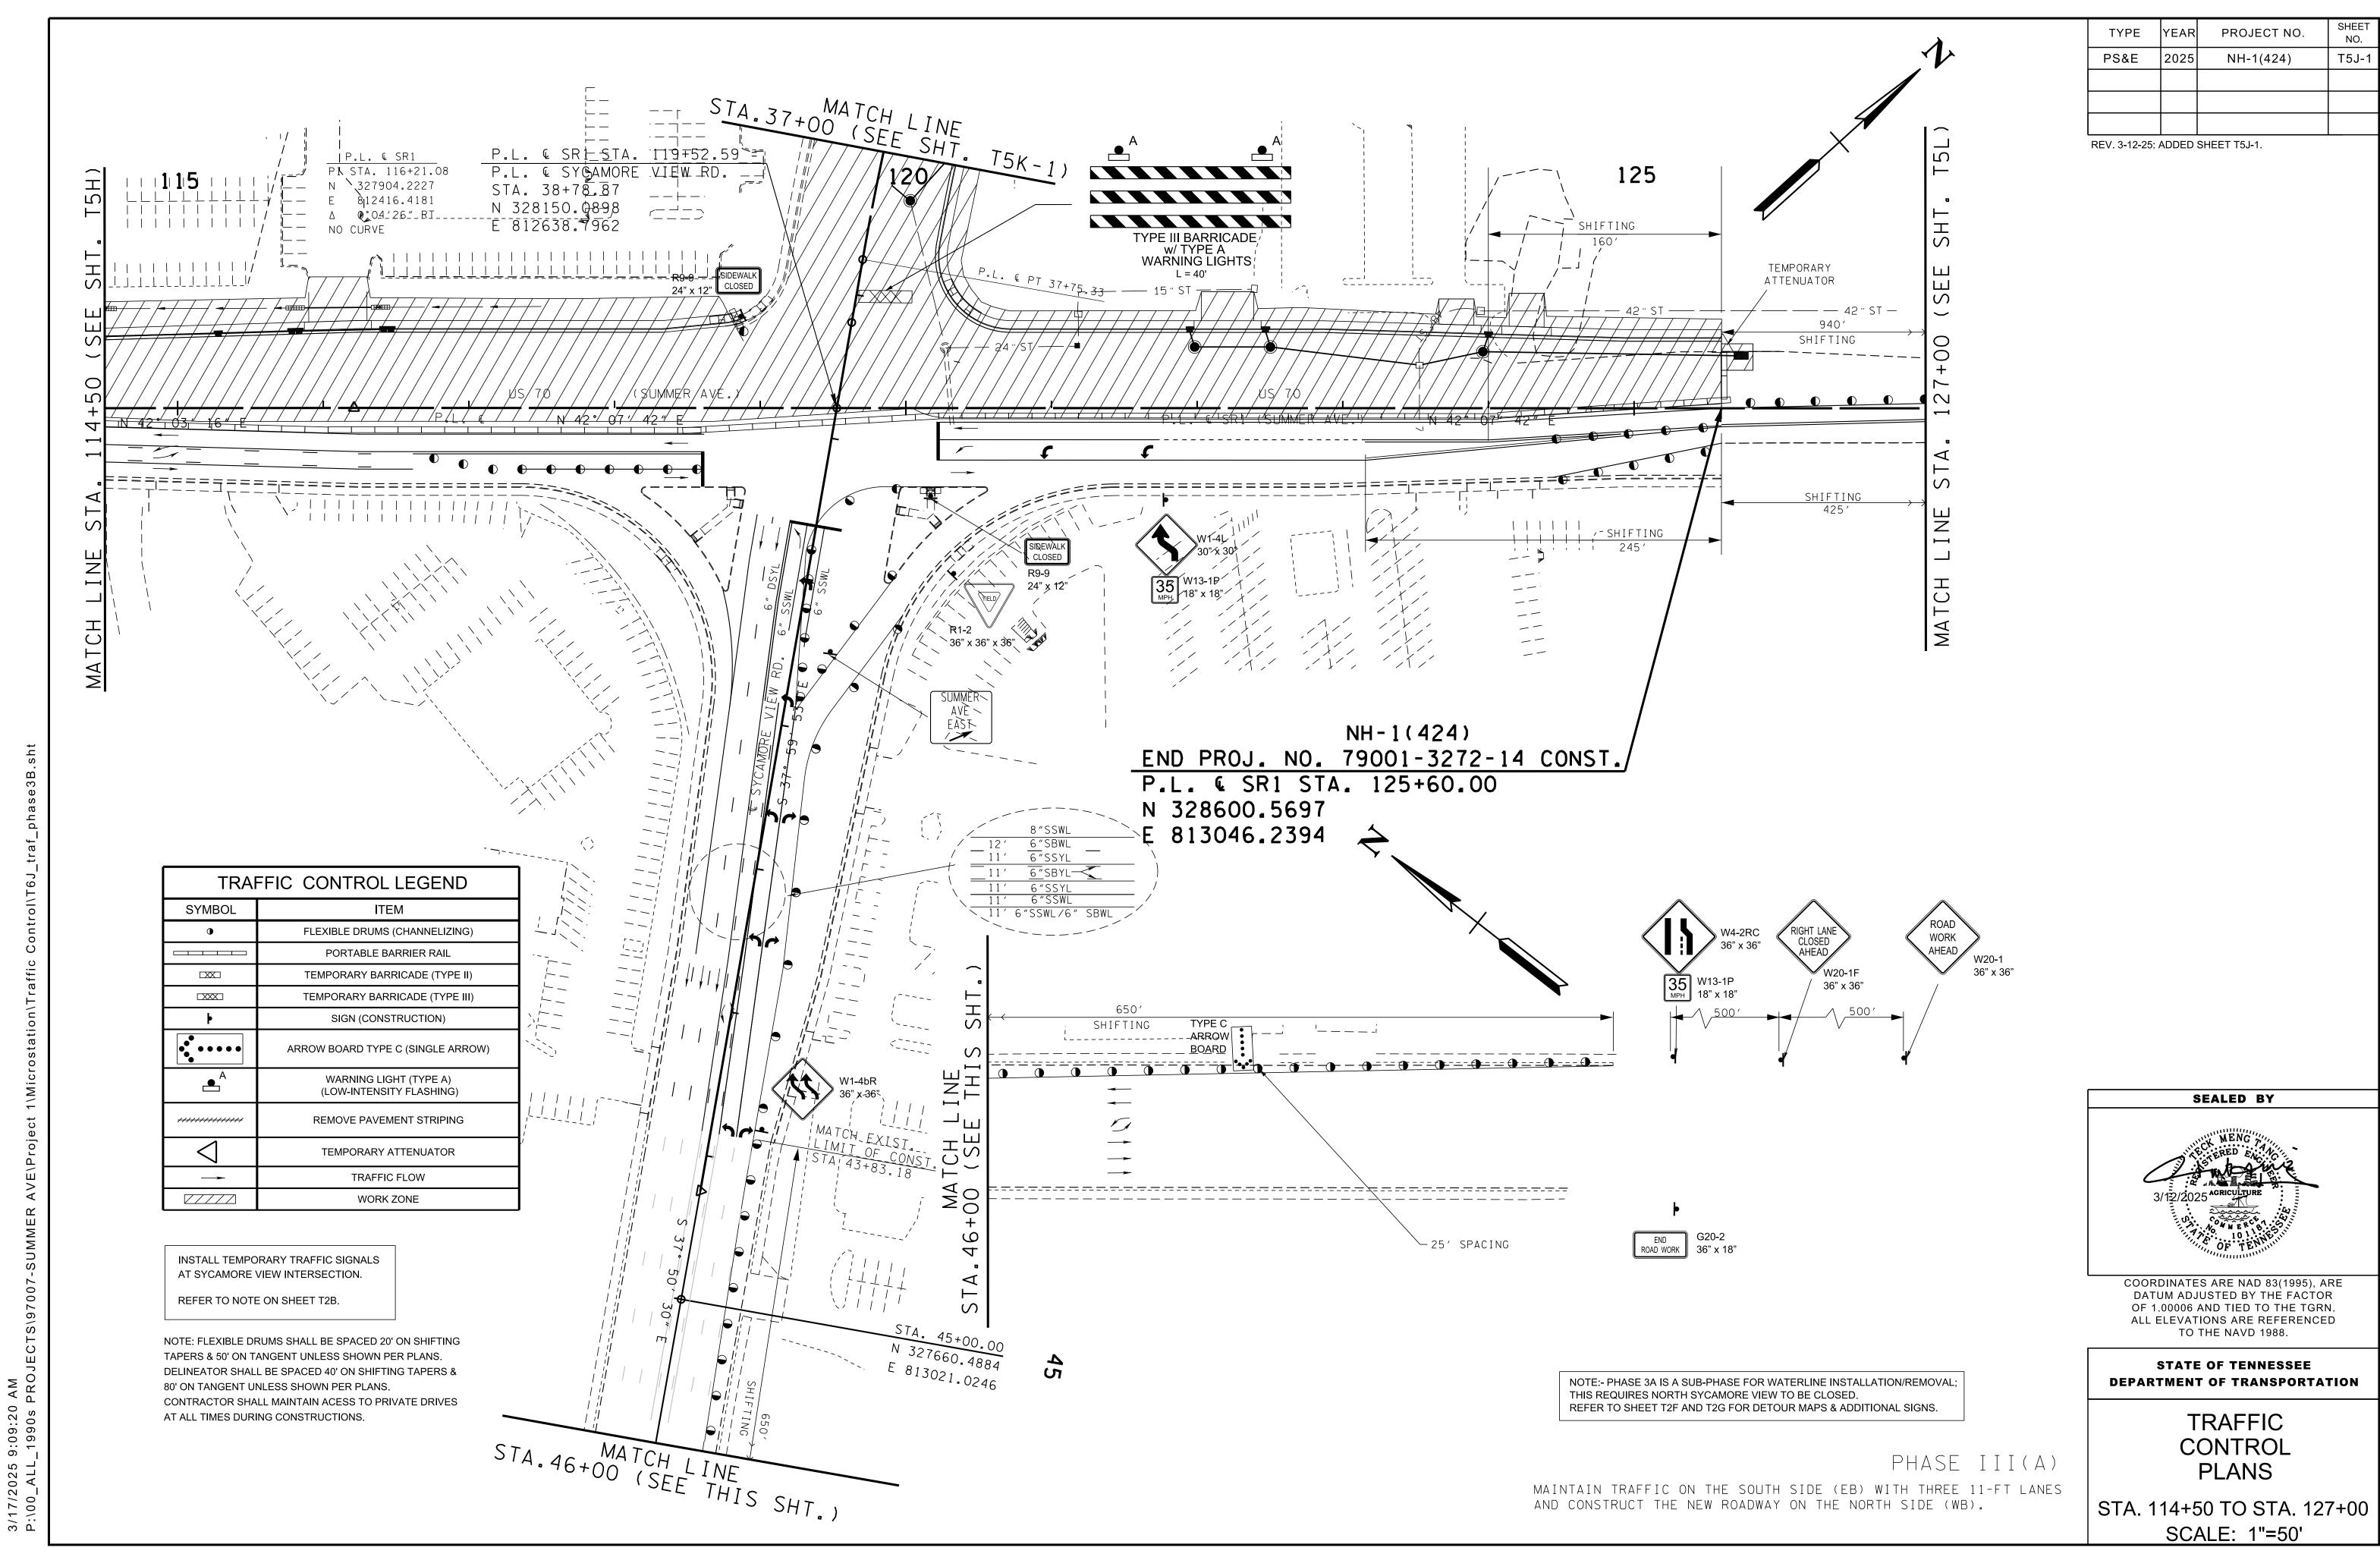
TO THE NAVD 1988.

STATE OF TENNESSEE

DEPARTMENT OF TRANSPORTATION


3/19/2025 10:29:08 AM P:\00_ALL_1990s PROJECTS\97007-SUMMER AVE\Project

MAINTAIN TRAFFIC ON THE SOUTH SIDE (EB) WITH THREE 11-FT LANES AND CONSTRUCT THE NEW ROADWAY ON THE NORTH SIDE (WB).



TYPE VEAD PROJECT NO REV. 3-12-25: ADDED EXISTING PAVEMENT MARKINGS AT SYCAMORE VIEW, NORTH OF PLEASANT VIEW.

TYPE	YEAR	PROJECT NO.	NO.
PS&E	2025	NH-1(424)	T5K

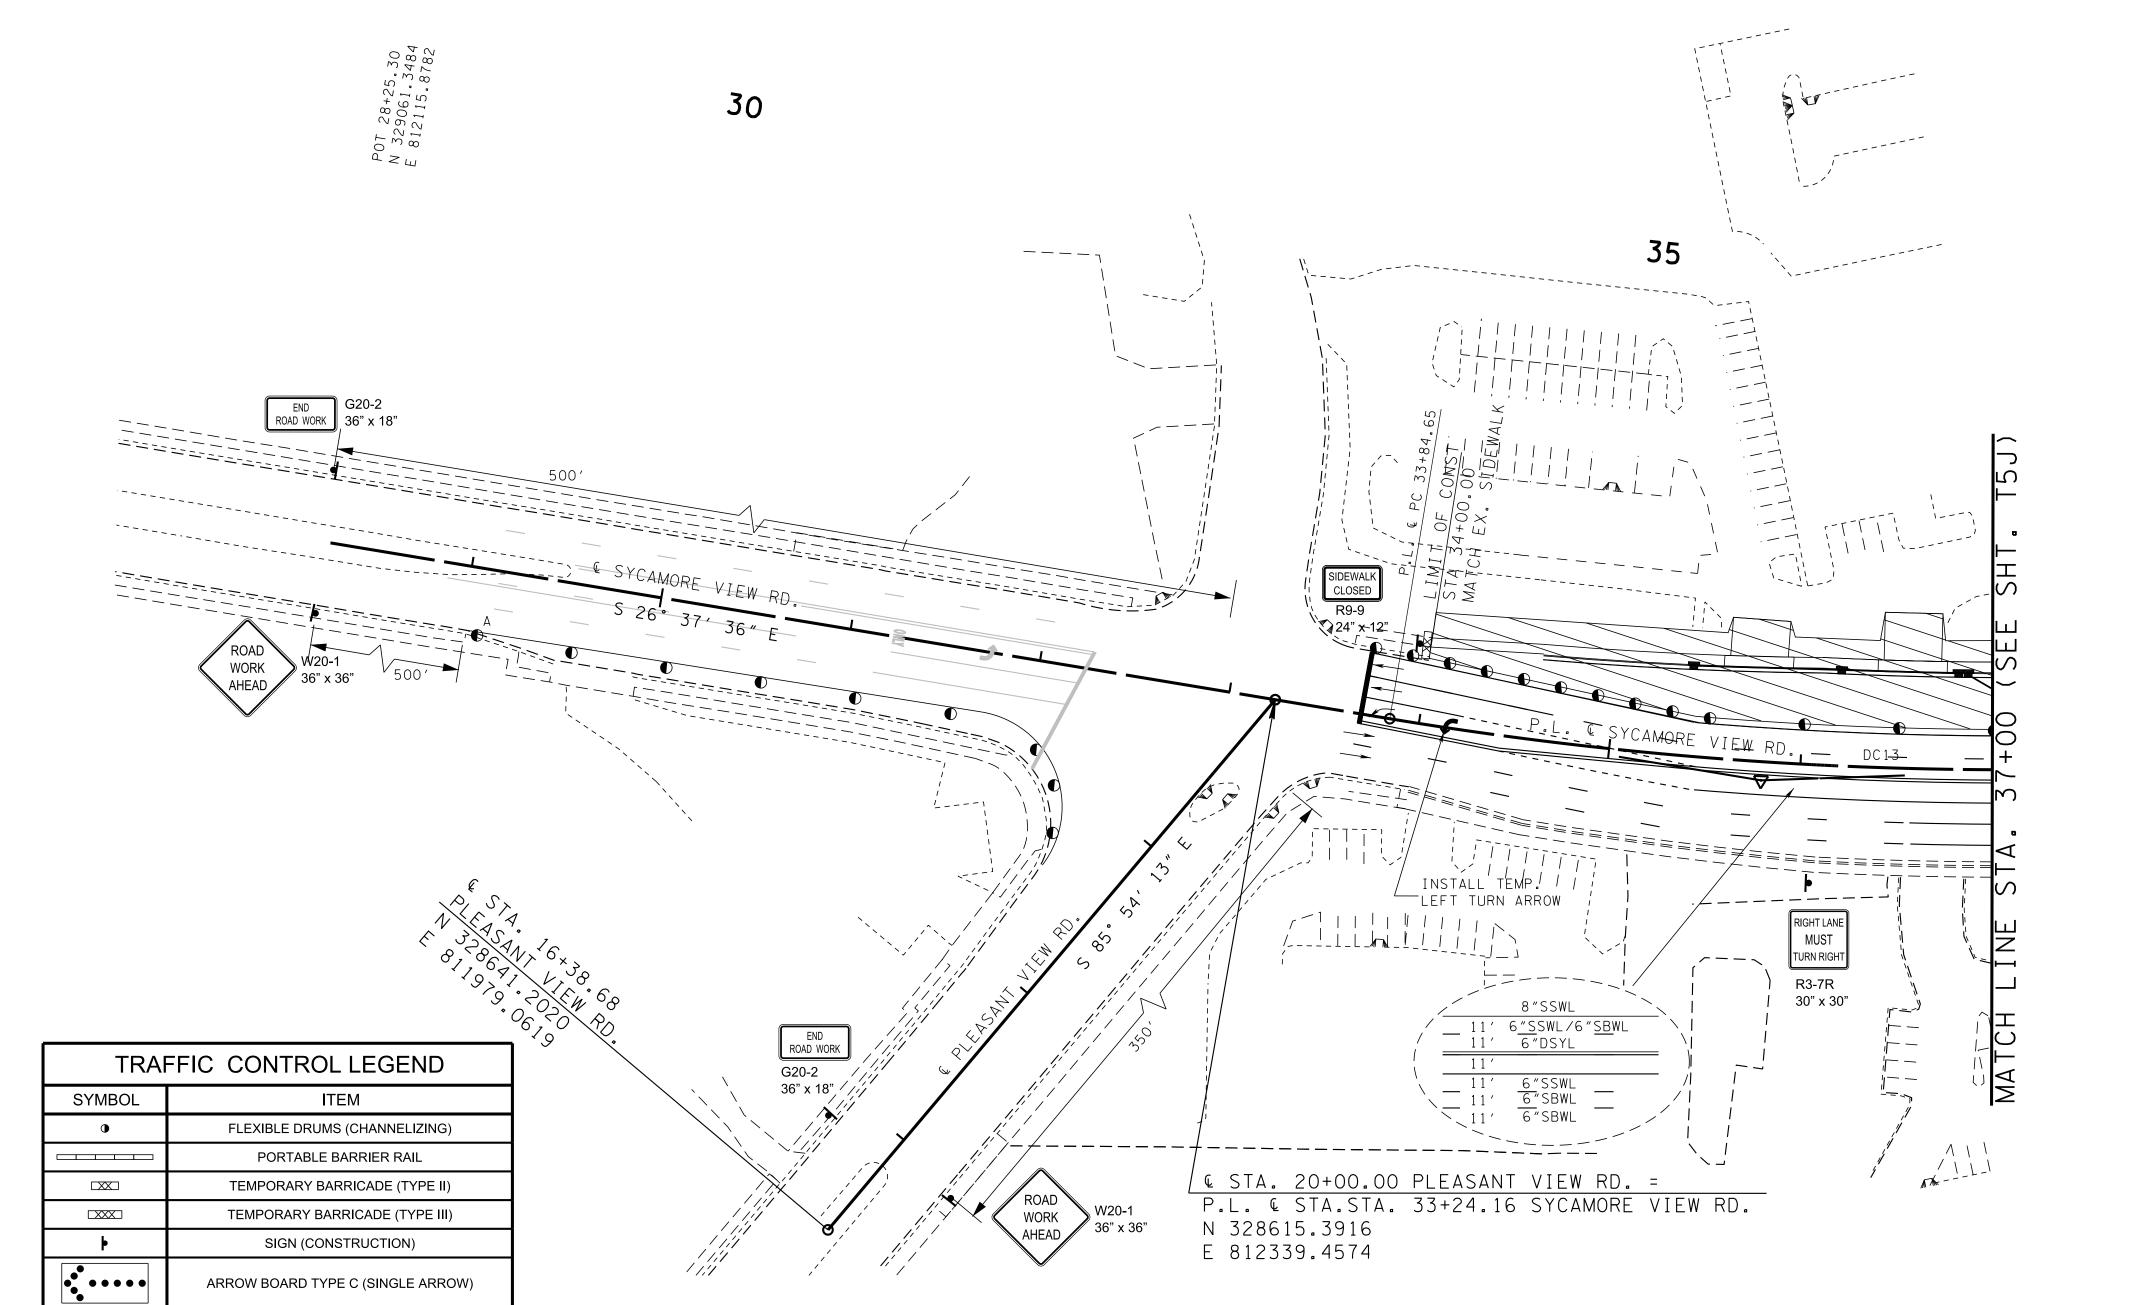

NOTE: FLEXIBLE DRUMS SHALL BE SPACED 20' ON SHIFTING

CONTRACTOR SHALL MAINTAIN ACESS TO PRIVATE DRIVES

TAPERS & 50' ON TANGENT UNLESS SHOWN PER PLANS. DELINEATOR SHALL BE SPACED 40' ON SHIFTING TAPERS &

80' ON TANGENT UNLESS SHOWN PER PLANS.

AT ALL TIMES DURING CONSTRUCTIONS.

WARNING LIGHT (TYPE A) (LOW-INTENSITY FLASHING)

REMOVE PAVEMENT STRIPING


TEMPORARY ATTENUATOR

TRAFFIC FLOW

WORK ZONE

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STATE OF TENNESSEE **DEPARTMENT OF TRANSPORTATION**

> TRAFFIC CONTROL **PLANS**

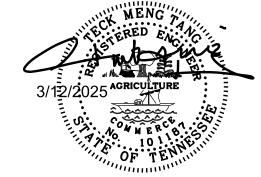STA. 37+00 TO L.O.C. SCALE: 1"=50'

PHASE III

MAINTAIN TRAFFIC ON THE SOUTH SIDE (EB) WITH THREE 11-FT LANES AND CONSTRUCT THE NEW ROADWAY ON THE NORTH SIDE (WB).

3/17/2025 9:09:43 AM P:\00_ALL_1990s PROJECT


TRAFFIC FLOW

WORK ZONE

	TYPE	YEAR	PROJECT NO.	SHEET NO.
	PS&E	2025	NH-1(424)	T5K-1
ſ				

REV. 3-12-25: ADDED SHEET T5K-1



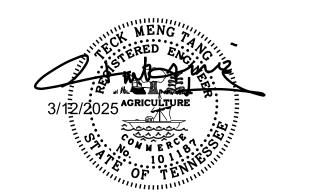

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STATE OF TENNESSEE
DEPARTMENT OF TRANSPORTATION

TRAFFIC CONTROL PLANS


STA. 37+00 TO L.O.C. SCALE: 1"=50'


PHASE III (A)

MAINTAIN TRAFFIC ON THE SOUTH SIDE (EB) WITH THREE 11-FT LANES AND CONSTRUCT THE NEW ROADWAY ON THE NORTH SIDE (WB).

TYPE	YEAR	PROJECT NO.	SHEET NO.
PS&E	2025	NH-1(424)	T5L

REV. 3-12-25: ADDED MATCHLINE SEE SHT. T5J-1

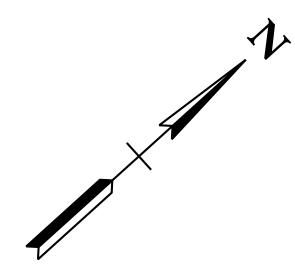

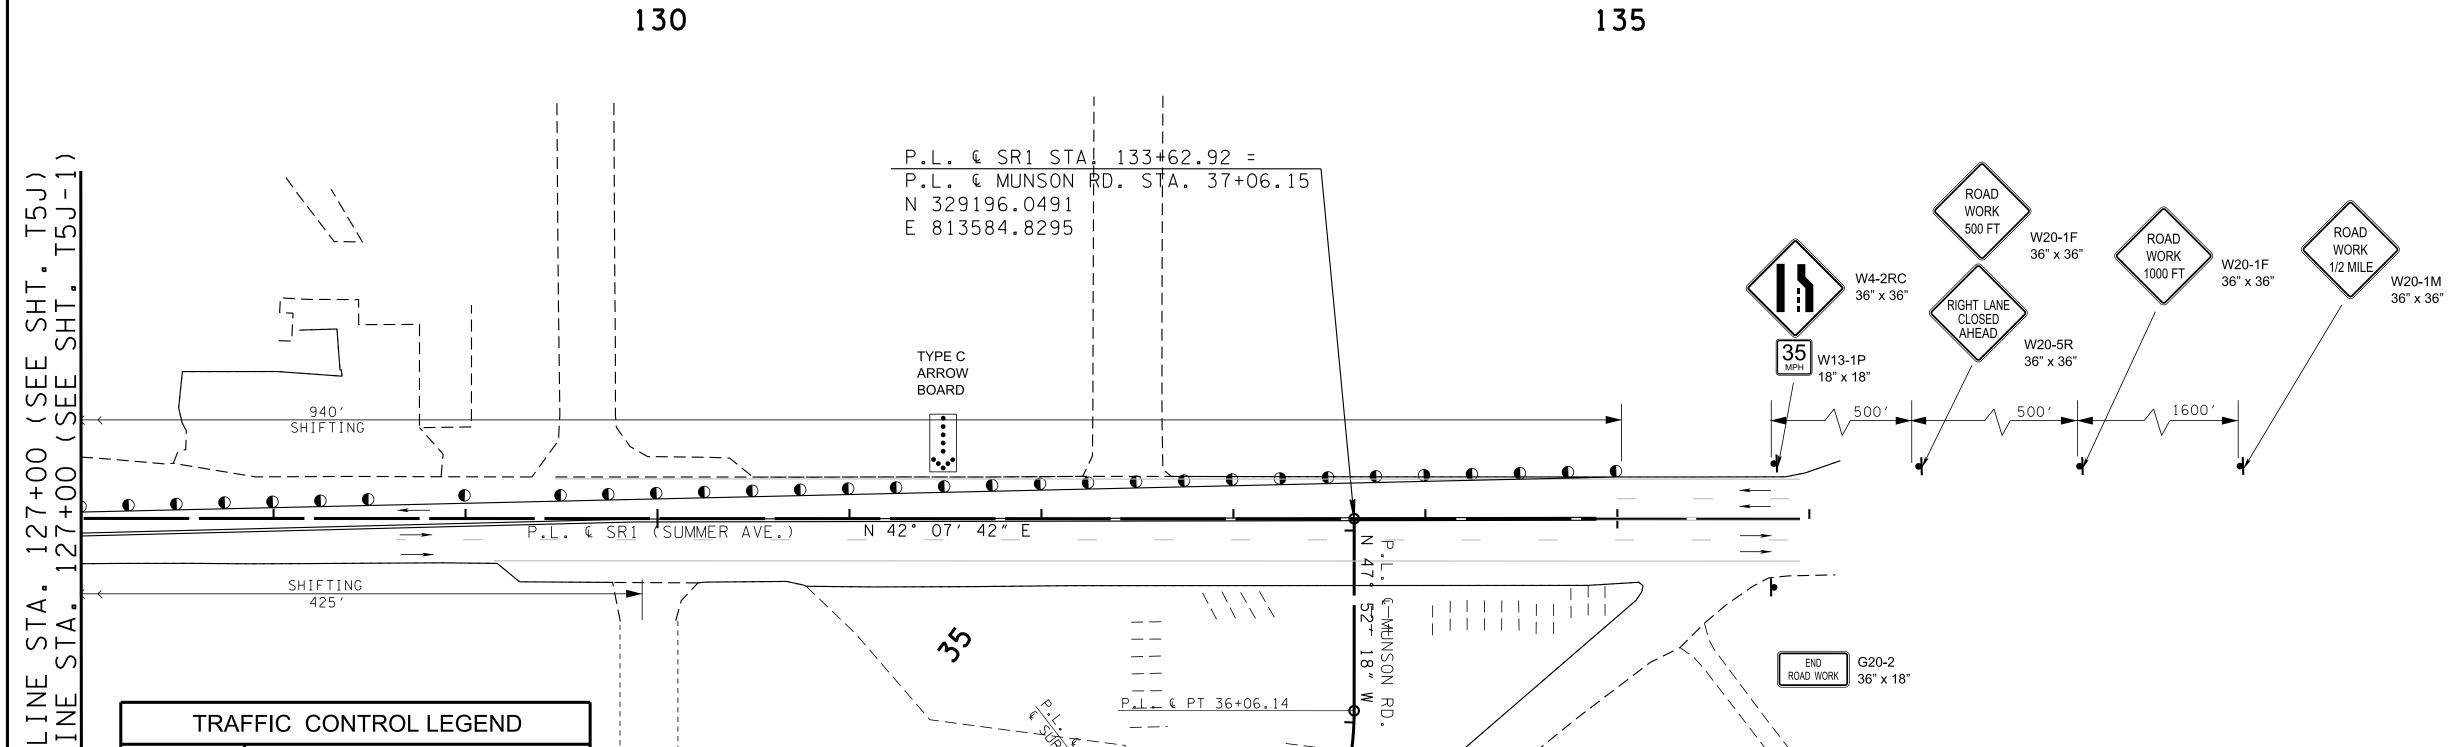

P.L. & MUNSON RD.

N 329,075.0075 E 813,718.6563 Δ 52° 14′ 23″ (LT)

CURVE DC14 PI 35+31.35

R 164.04

L 149.57 T 80.43

SE NC

TRAFFIC CONTROL LEGEND		
SYMBOL	ITEM	
•	FLEXIBLE DRUMS (CHANNELIZING)	
	PORTABLE BARRIER RAIL	
	TEMPORARY BARRICADE (TYPE II)	
	TEMPORARY BARRICADE (TYPE III)	
ŀ	SIGN (CONSTRUCTION)	
•••••	ARROW BOARD TYPE C (SINGLE ARROW)	
<u></u> ^A	WARNING LIGHT (TYPE A) (LOW-INTENSITY FLASHING)	
/////////////////////////////////////	REMOVE PAVEMENT STRIPING	
	TEMPORARY ATTENUATOR	
	TRAFFIC FLOW	
	WORK ZONE	

MATCH MATCH L

3/19/2025 10:29:33 AM P:\00_ALL_1990s PROJECTS\97007 NOTE: FLEXIBLE DRUMS SHALL BE SPACED 20' ON SHIFTING TAPERS & 50' ON TANGENT UNLESS SHOWN PER PLANS.

DELINEATOR SHALL BE SPACED 40' ON SHIFTING TAPERS & 80' ON TANGENT UNLESS SHOWN PER PLANS.

CONTRACTOR SHALL MAINTAIN ACESS TO PRIVATE DRIVES AT ALL TIMES DURING CONSTRUCTIONS.

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STATE OF TENNESSEE DEPARTMENT OF TRANSPORTATION

TRAFFIC CONTROL PLANS

STA. 127+00 TO END OF PROJ. SCALE: 1"=50'

PHASE III

MAINTAIN TRAFFIC ON THE SOUTH SIDE (EB) WITH THREE 11-FT LANES AND CONSTRUCT THE NEW ROADWAY ON THE NORTH SIDE (WB).